


PUBLIC HEALTH SUDBURY AND DISTRICTS - WALL REMEDIATION WEST STAIRWELL

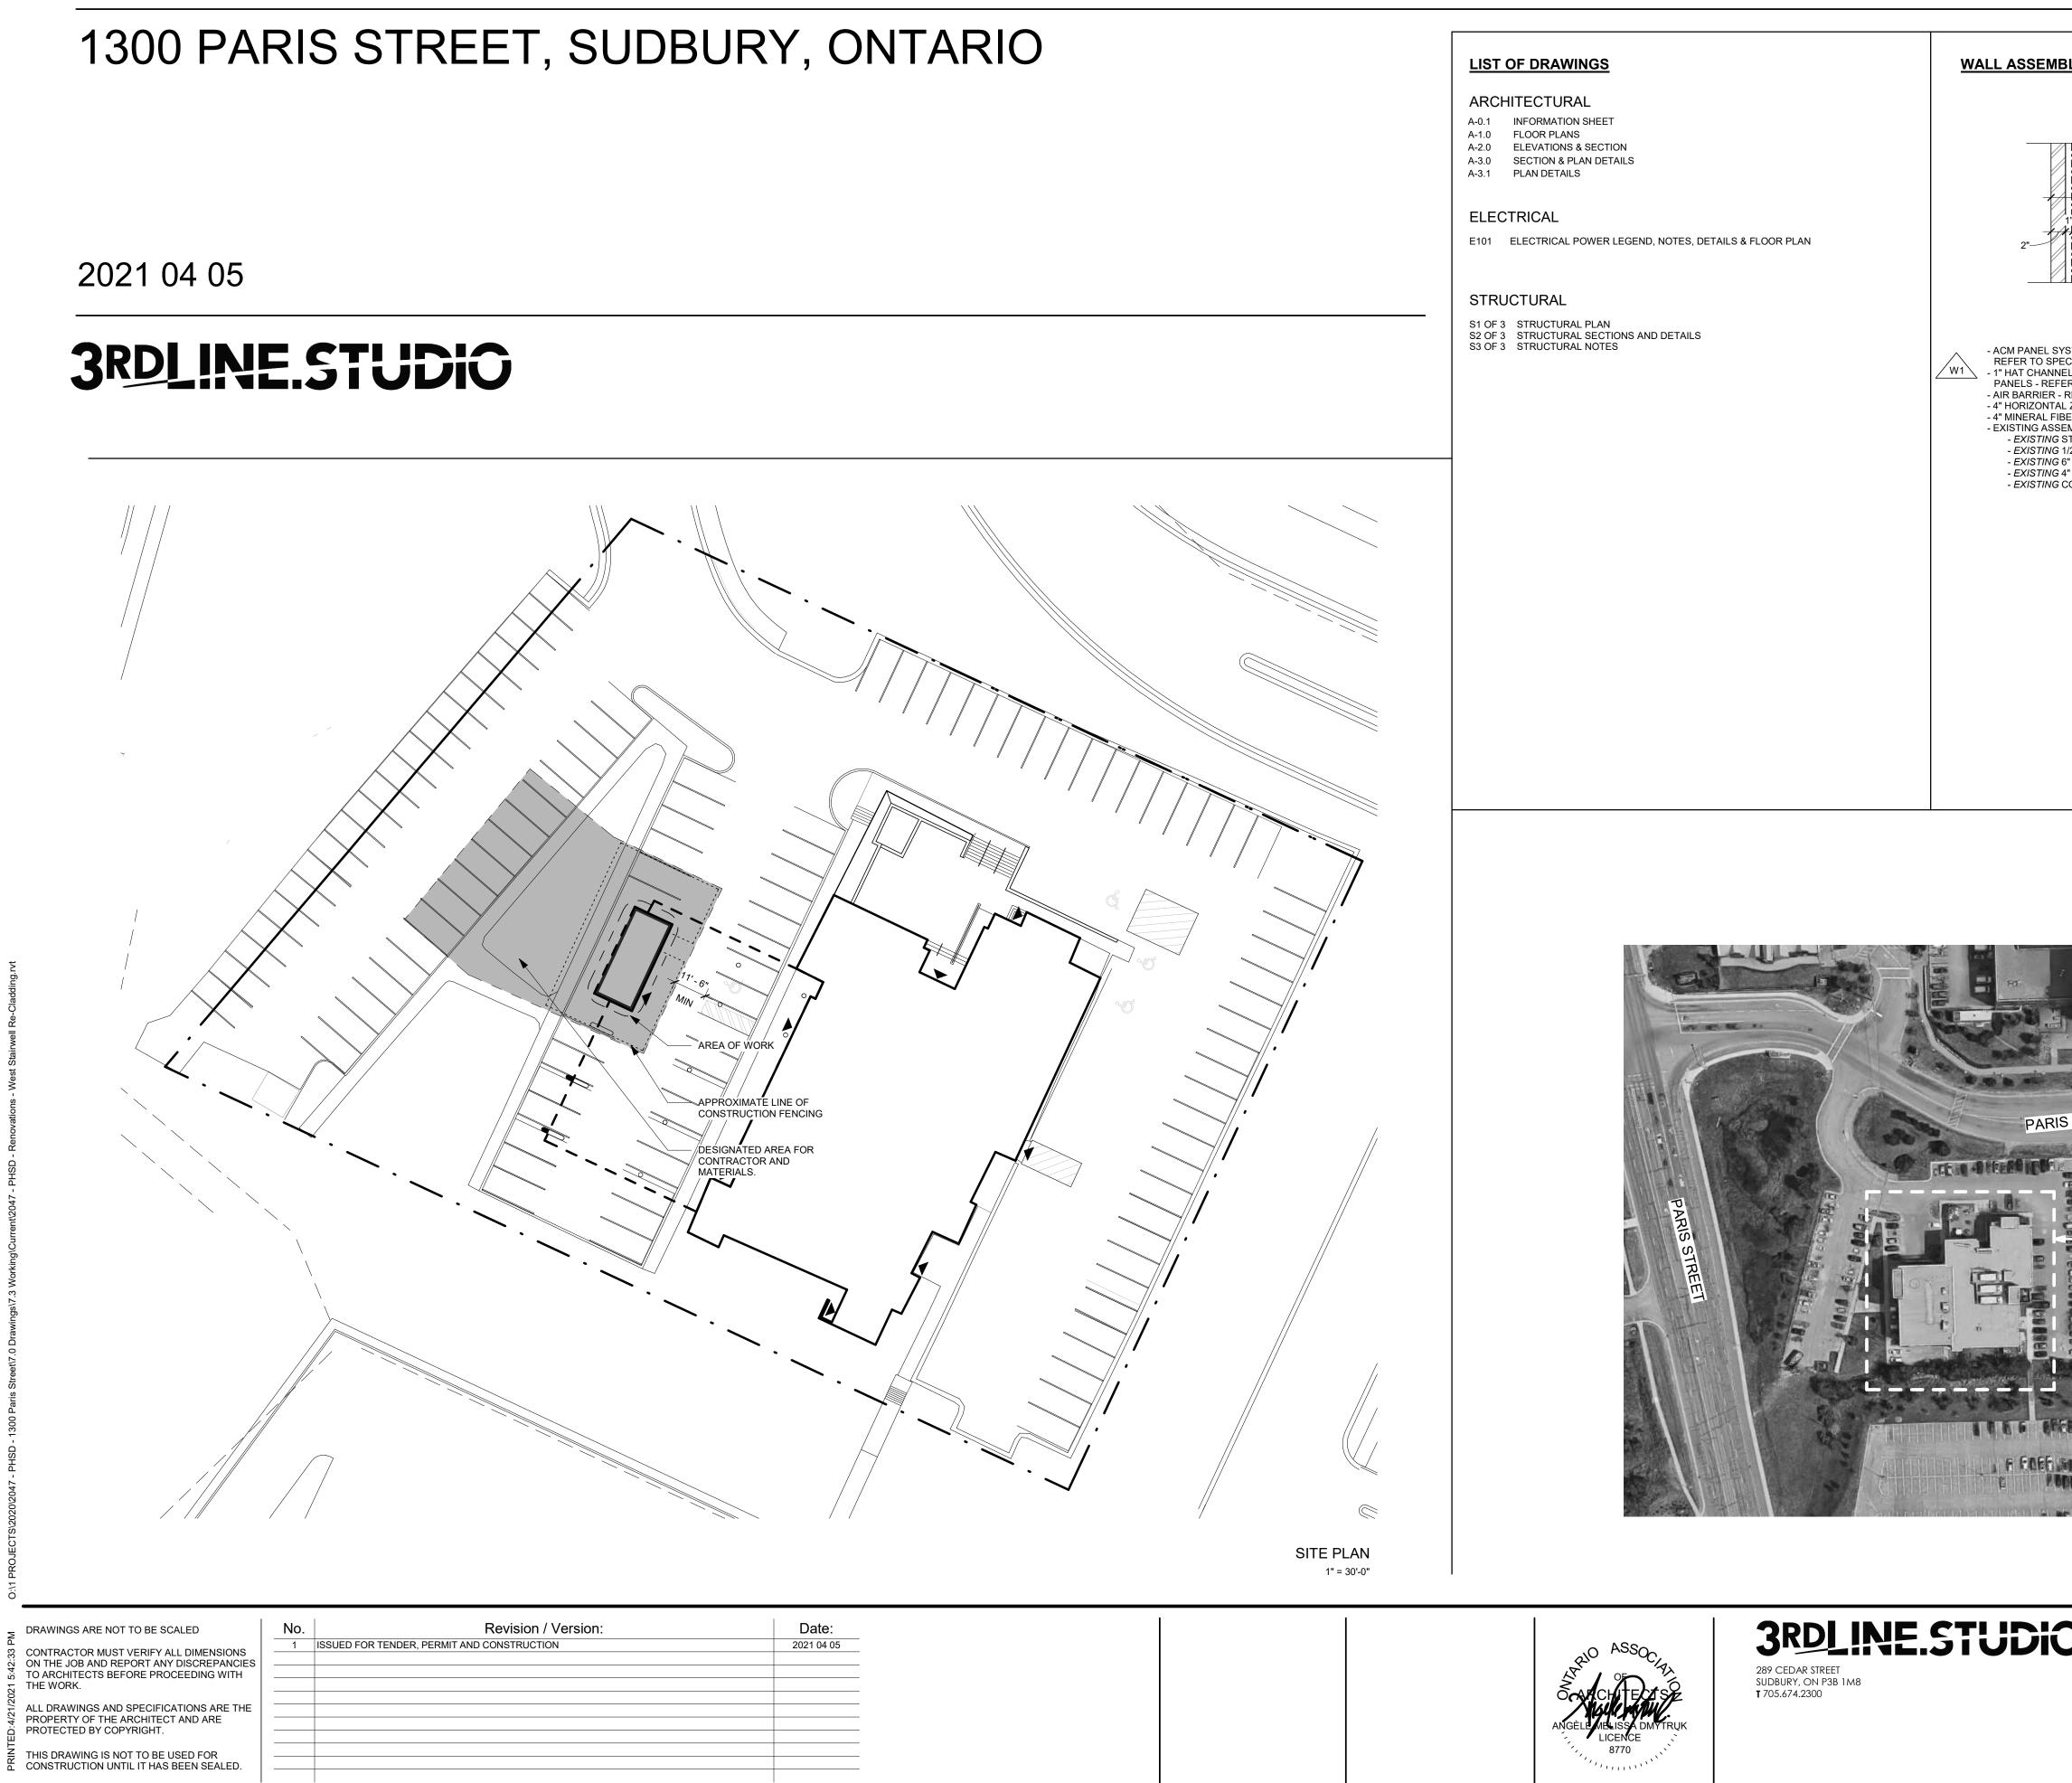

	SYMBOL BLOCK NAME
AT	VIEW NAME 1 1:100 A-2.0 SECTION NUMBER, TITLE AND SCALE REFERENCE
	VIEW NAME 1:100 TITLE AND SCALE REFERENCE
	ROOM NAME ROOM NAME AND NUMBER
	FLOOR ELEVATION REFERENCE TO 0.0 LEVEL AS NOTED
	R1 CONSTRUCTION ROOF ASSEMBLY REFERENCE
	W1 CONSTRUCTION WALL ASSEMBLY REFERENCE TAG
+/- 1' - 11 5/8" +/- 6" +/- 10" +/- 1/2" +/- 1/8"	DOOR AND FRAME REFERENCE
	BUILDING SECTION REFERENCE
FION VIEW INSTALLED AS PER MANUFACTURERS INSTRUCTIONS - ELEVATIONS CED AT MAX. 16" O.C. AND AS REQUIRED TO SUIT ACM PECS TO SPECS. IS SPACED AT 24" O.C. FASTENED TO EXISTING Z-GIRTS ILATION - REFER TO SPECS ISSUMED ASSEMBLY AS FOLLOWS: FINISH ENT BOARD	1 A-5.0 DETAIL REFERENCE
	 GENERAL NOTES ARCHITECTURAL DRAWINGS ARE TO BE READ IN CONJUNCTION WITH ELECTRICAL DRAWINGS. IT IS THE CONTRACTORS RESPONSIBILITY AT TIME OF TENDER TO REPORT ANY DISCREPANCIES BETWEEN ARCHITECTS AND CONSULTANTS DRAWINGS. FAILURE TO DO SO MAY VOID, AT OWNERS DISCRETION ANY CLAIM FOI COMPENSATION. ANY DISCREPANCIES, OMISSIONS, OR CONFLICTS SHALL BE REPORTED TO ARCHITECT PRIOR TO WORK PROCEEDING. PRIOR TO CLADDING LAYOUT, SITE VERIFY ALL FORESEEABLE INTERFERENCES AN REPORT TO ARCHITECT. +/- NEXT TO ANY DIMENSION INDICATES THAT MEASUREMENT SHOULD BE FIELD VERIFIED AND MAY HAVE TO BE ADJUSTED TO ACCOMMODATE SITE CONDITIONS. REPORT TO ARCHITECT AS REQUIRED IF DESIGN INTENT CANNOT BE IMPLEMENTED
SCENT	MODULAR CO-ORDINATION NOTES ALL WORKING DRAWING ARE DIMENSIONED BY THE MODULAR COORDINATION METHOD IN CONFORMANCE WITH THE SERIES OF STANDARDS FOR METRIC DIMENSIONAL COORDINATION IN BUILDING CAM3-A31, M-75. THE POSITION AND SIZE OF BUILDING COMPONENTS IN THIS DRAWING ARE CONTROL BY THE BASIC MODULAR GRID OF 100 mm. (4"). GRID LINES OR POINTS ON GRID LINES ARE LOCATED ON THE DIMENSION LINE BY ARROWHEAD. ELEVATION, OR SECTION SHOW DIMENSION TO GRID LINES OR TO NOMINAL SURFACE OF AN OFF-GRID COMPONENT OR TO CENTER LINE OF CONSTRUCTION ASSEMBLY. LARGE SCALE DETAIL DRAWING SHOW DIMENSIONS FROM GRID LINES TO ACTUAL SURFACE OF A COMPONENT. MPERIAL Imperial Imperial
SITE LOCATION F G F	ACTUAL SURFACE
E CALER P. I.	
ST IMAGE SEE	ARCHITECT: 3RDLINE.STUDIO 289 Cedar Street, Suite 300, Sudbury, Ontario P3B 1MB Tel: 705-674-2300 Fax: 705-674-2185 Email: admytruk@3rdline.studio
ET BEREFE INDERF	MECHANICAL/ Piotrowski Consultants Ltd. ELECTRICAL 1829 Bond Street, North Bay, ON P1B 4V6 ENGINEER: Tel: 705-472-2536 Email: jbak@piotrowskiconsultants.ca
SITE LOCATION	A2S Associates Limited ENGINEER: 289 Cedar St, Suite 201, Sudbury, Ontario P3B 1M8 Tel: 705-222 0420 Email: aaron@a2sa.ca

1300 PARIS ST. SUDBURY, ON P3E 3A3 **INFORMATION SHEET**

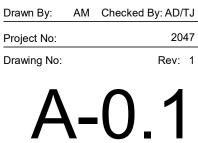


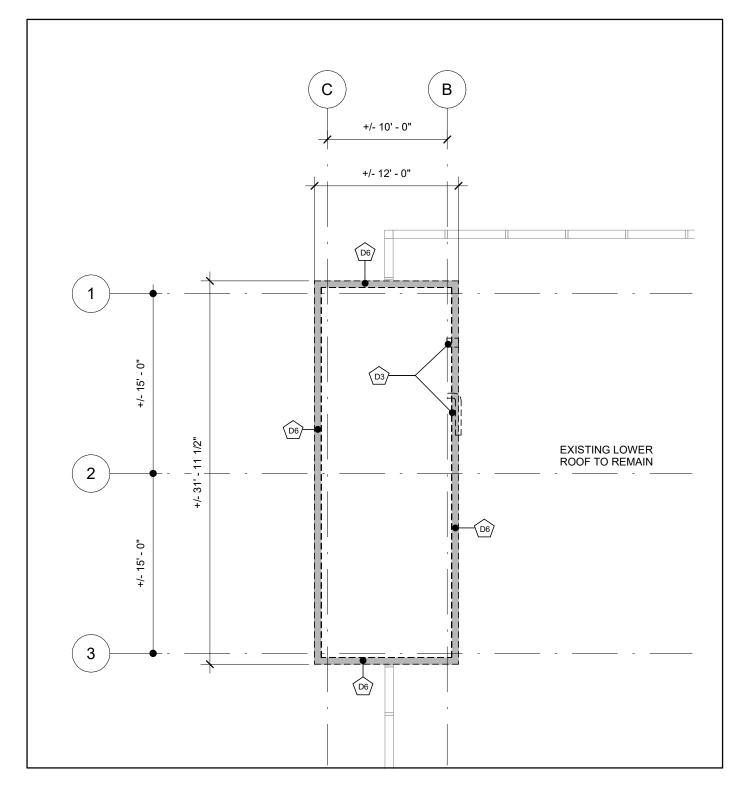




EXISTING GAS PIPE AND ELECTRICAL FEED TO REMAIN. PROTECT FROM DAMAGE.



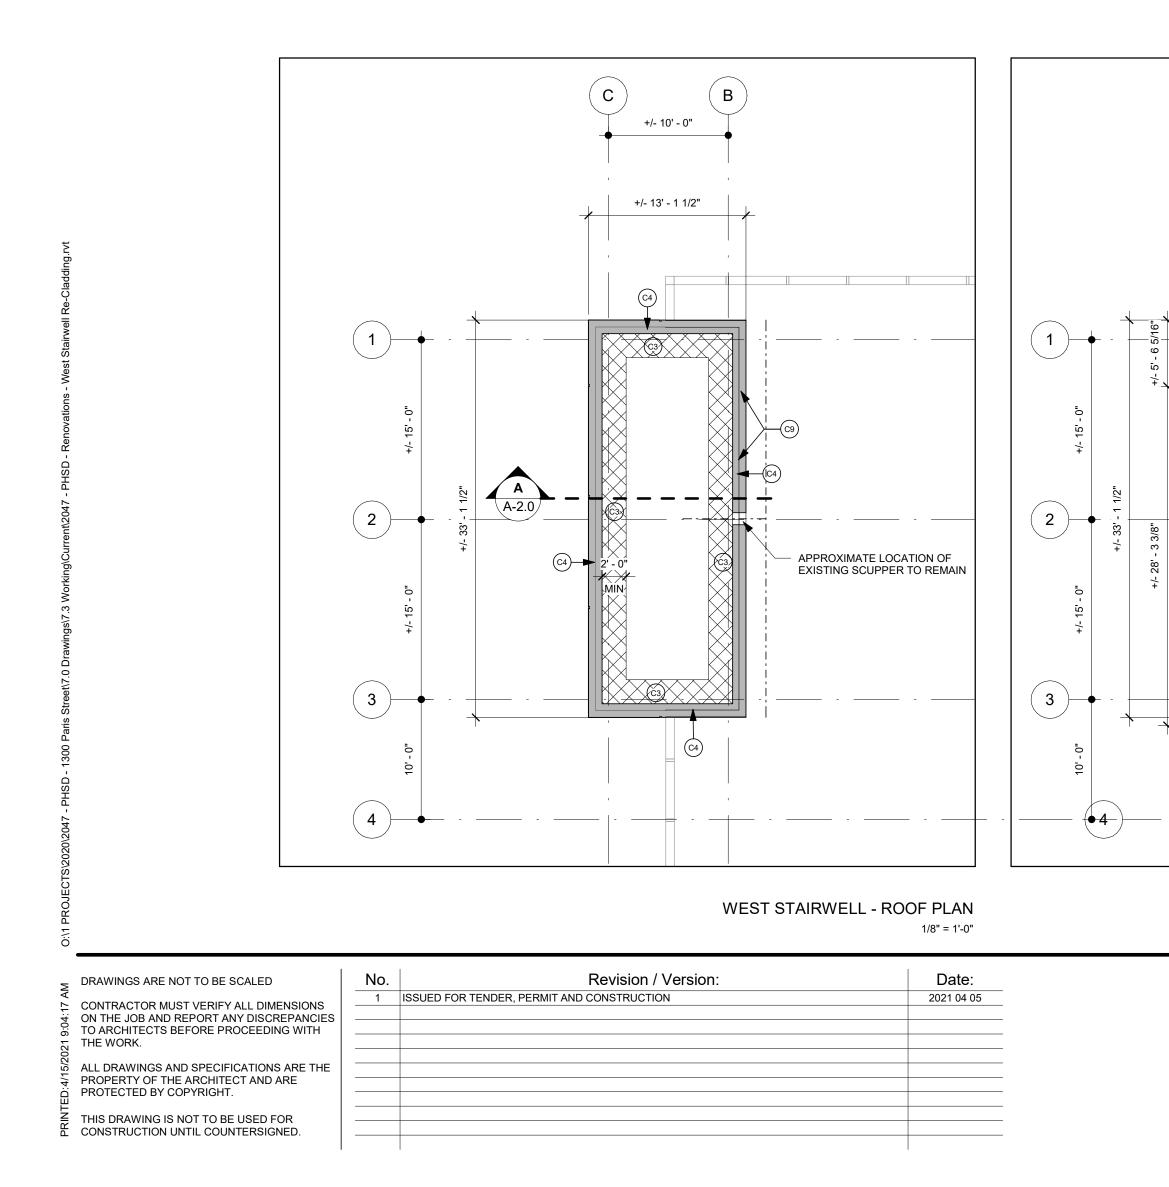

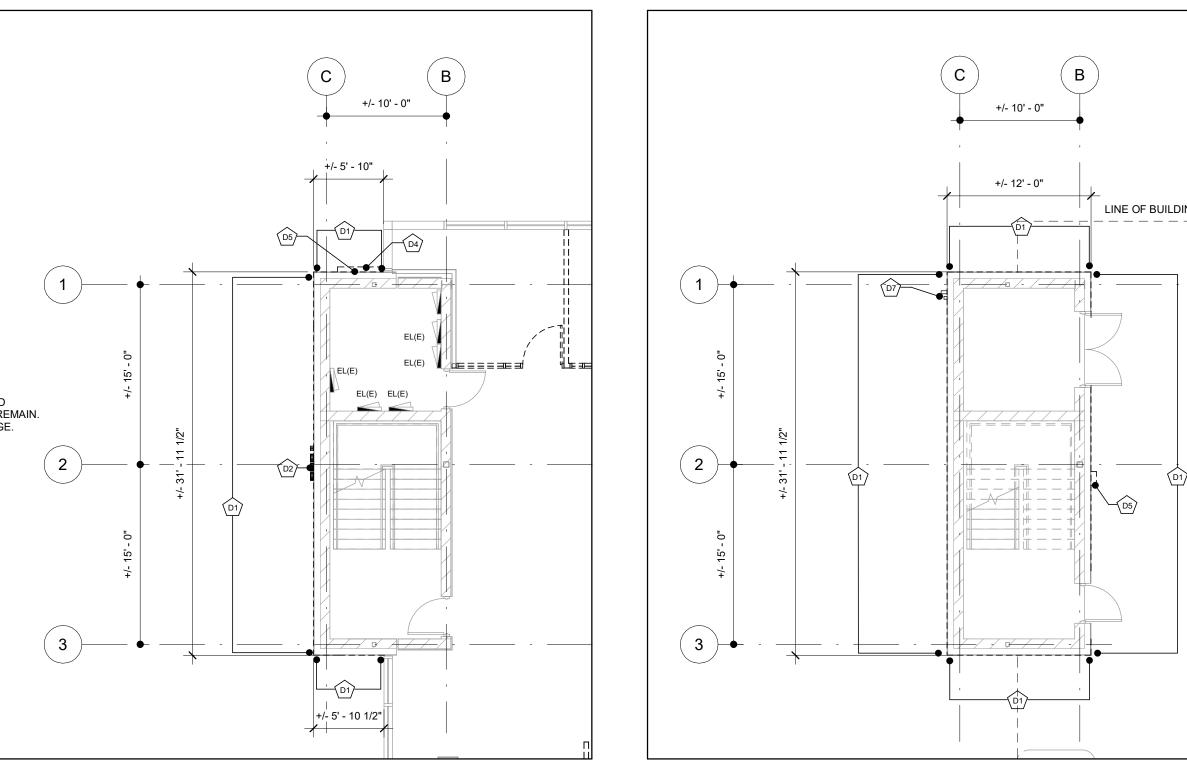

WEST STAIRWELL - LEVEL TWO/THREE DEMOLITION FLOOR PLAN 1/8" = 1'-0"

 \frown **C**)

+/- 6' - 5"

∕w1∖

ELEC(EX)

233

EP(E) EP(E)

SD(EX)

SD-2

+/- 3' - 4" | +/- 3' - 9 1/2"

₩1

<u>C6</u><u>C6a</u>

C7)-

∕w1`


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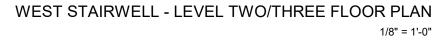
∖^{A-3.1}∕ SIM

+/- 10' - 0"



WEST STAIRWELL - LEVEL


FLOOR PLANS

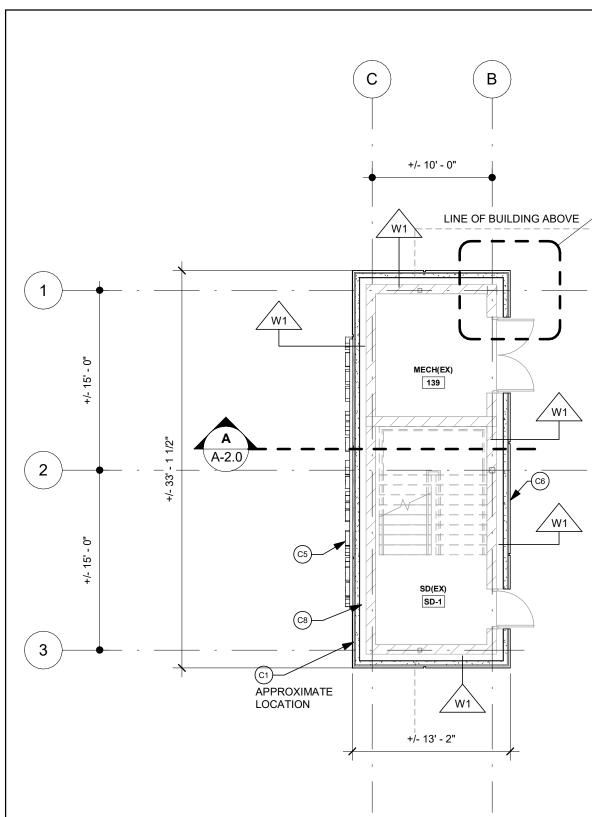

P2 SIM


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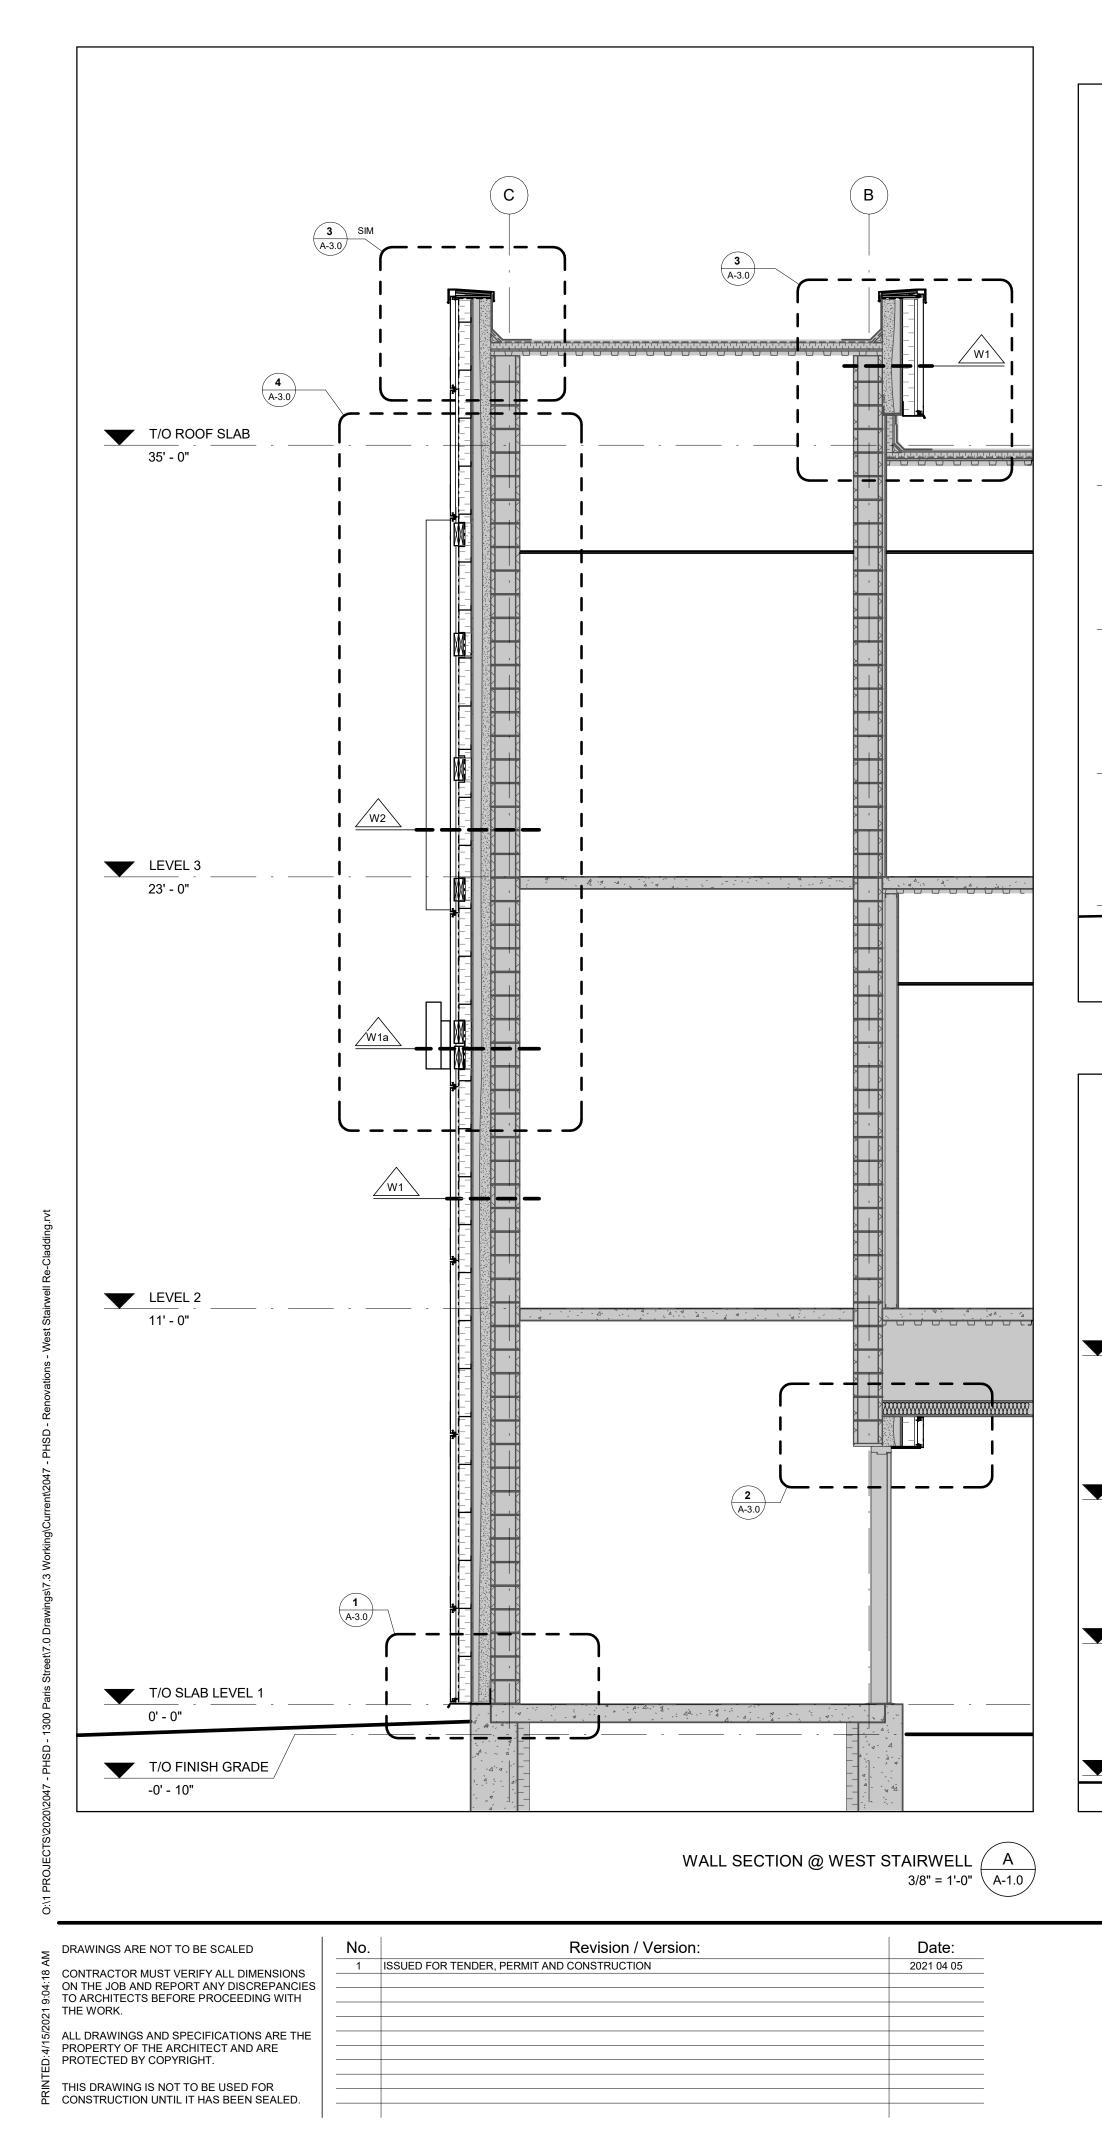



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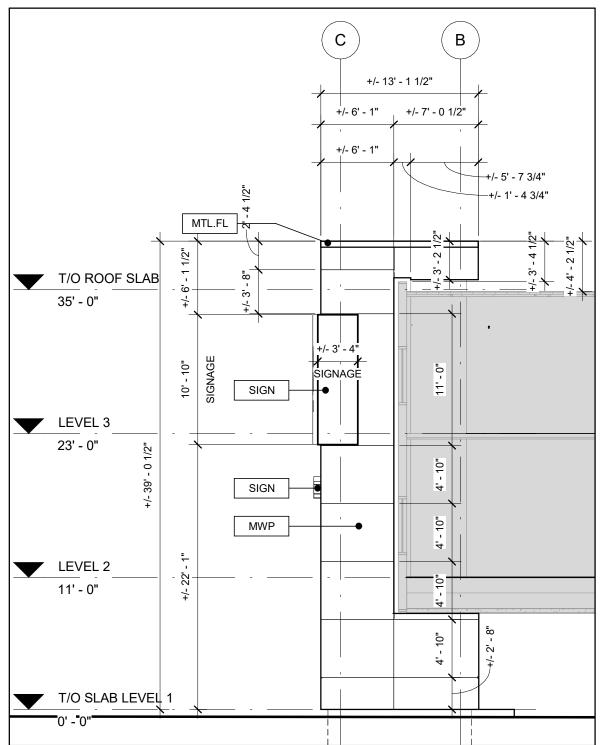
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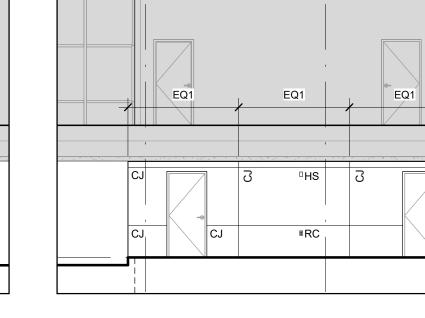


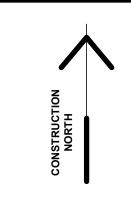
C H H 12'-0" Image: Comparison of the state o	 A OTHER PERMANENT FIXTURES FROM DAMAGE DURING DEMOLITION AND CONSTRUCTION OF THE WORK. AS A MINIMUM USE POLYETHYLENE AND PLYWOOD HOARDING. 8. PROTECT EXISTING MECHANICAL AND ELECTRICAL SYSTEMS TO REMAIN, PROVIDE WATERTIGHT ENCLOSURE AT THESE SYSTEMS WHEN EXPOSED TO THE ELEMENTS. 9. PROTECT EXISTING SITE FINISHES FROM DAMAGE DURING DEMOLITION AND CONSTRUCTION. PROVIDE PROTECTION AS REQUIRED TO SUIT. ANY SITE FINISHES DAMAGED FROM WORK TO BE REPAIRED AND RE-INSTATED TO ITS ORIGINAL STATE. 	 REMOVE EXISTING SIGNAGE. MAKE GOOD ALL SURFACES IN PREPARATION FOR NEW. REMOVE EXISTING BOILER VENTING & AIR INTAKE. REMOVE EXISTING EXHAUST GRILLES TO BE REPLACED WITH NEW. SEE PHOTO FOR APPROXIMATE LOCATIONS BUTTO TO HON TO TO HORN STROBE, JUNCTION BOX & PHOTOCELL TO BE REMOVED. MAKE SAFE ALL ELECTRICAL REPS SAFE FOR RE-INSTALLATION. REFER TO ELECTRICAL DRAWINGS. REMOVE EXISTING PARAPET CAP FLASHING, OVERLAPPED ROOF MEMBRANE, AND ALL RELATED ACCESSORIES IN PREPARATION FOR NEW CONSTRUCTION. EXISTING GAS PIPE AND ELECTRICAL FEED TO REMAN. PROTECT FROM DAMAGE.
UNE OF BUILDING ABOVE	 BUILDING IS TO BE KEPT WEATHER TIGHT AT ALL TIMES DURING CONSTRUCTION. WHERE EXISTING CEMENT BOARD IS MISSING OR DAMAGED PATCH AND REPAIR WITH MATERIALS OF LIKE KIND AND QUALITY TO ENSURE SPRAYFOAM IS PROTECTED. 	 CONSTRUCTION NOTES (TAGS): INSTALL NEW 4' SPRAYFOAM AND 1/2' CEMENT BOARD WHERE EXISTING SPRAYFOAM WAS REMOVED FOR INSTALL TWO (2) NEW MECHANICAL LOUVERS BY CONSTRUCTION SPECIALITIES #1100 cw SCREEN SJZE TO ACHADING COLOUR TO MATCH NEW METAL CLADDING. INSTALL TWO (2) NEW MECHANICAL LOUVERS BY CONSTRUCTION SPECIALITIES #1100 cw SCREEN SJZE TO ACHADING COLOUR TO MATCH NEW METAL CLADDING. ISEAL NEW EPDM MEMBRANE ONTO EXISTING MOOF MEMBRANES UNTH HOT FLOOD COAT A MINUM OF 2-0°. REFER TO DETAILS ON SHEET A-5. IPROVIDE NEW PARAPET FLASHING, COLOUR TO MATCH NEW CLADDING, REFER TO DETAILS AND SPECIFICATIONS. IPROVIDE NEW PARAPET FLASHING, COLOUR TO MATCH WITH SIGNAGE CONSULTANT. REFER ALSO TO ELEVATIONS & SECTIONS FOR ADDITIONAL INFORMATION. IPROVIDE NEW SIGNAGE CONTRACTOR TO COORDINATE WITH SIGNAGE CONSULTANT. REFER ALSO TO ELEVATIONS & SECTIONS FOR ADDITIONAL INFORMATION. IPROVIDE CLADING. REFER TO DETAILS AND SPECIFICATIONS & SECTIONS FOR ADDITIONAL INFORMATION. IPROVIDE FLASHING SHOLL TO MATCH COLOUR OF NEW CLADDING. ELECTRICAL FEED COLOUR DED MOLTER SIGNAD SHEET A-50. IPROVIDE FLASHING BHIND CAS AND ELECTRICAL FEED, CUT DELECTRICAL FEED ACUMP PROVIDE FLASHING AS AND ELECTRICAL FEED, CUT O SUIT. WALL ASSEMBLY TO LOUS SAMED ACUOUND PIE AND ELECTRICAL FEED COLOUR AS AROUND WALL ASSEMBLY ALL ALSAHING TO MATCH COLOUR OF NEW CLADDING. IPROVIDE FLASHING AND SCRAPE BACK SPRAYFOAM AS REQUIRED FAIL ASSEMBLY ALL FLASHING TO MATCH COLOUR OF NEW CLADDING. IPROVIDE CLADING. IPROVIDE THALS AND STRUCTURAL DRAWINGS. IPATCH AND REPAR HOLL AS REQUIRED, FILL VOID WITH MIRERAL FIBER HISULATION, NEW SHEATHNE IN STRUCTURAL DRAWINGS. IPATCH AND REPAR HOLL AS REQUIRED. FILL VOID WITH MIRERAL FIBER HISULATION, NEW SHEATHNE IN STRUCTURAL DRAWINGS.
289 CEDAR STREET SUDBURY, ON P3B 1M8 T705.674.2300	PUBLIC HEALTH SUDBURY AND DIS WALL REMEDIATION AT WEST STA 1300 PARIS ST. SUDBURY, ON P3E 3A3 FLOOR PLANS	Scale: As indicated





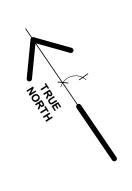


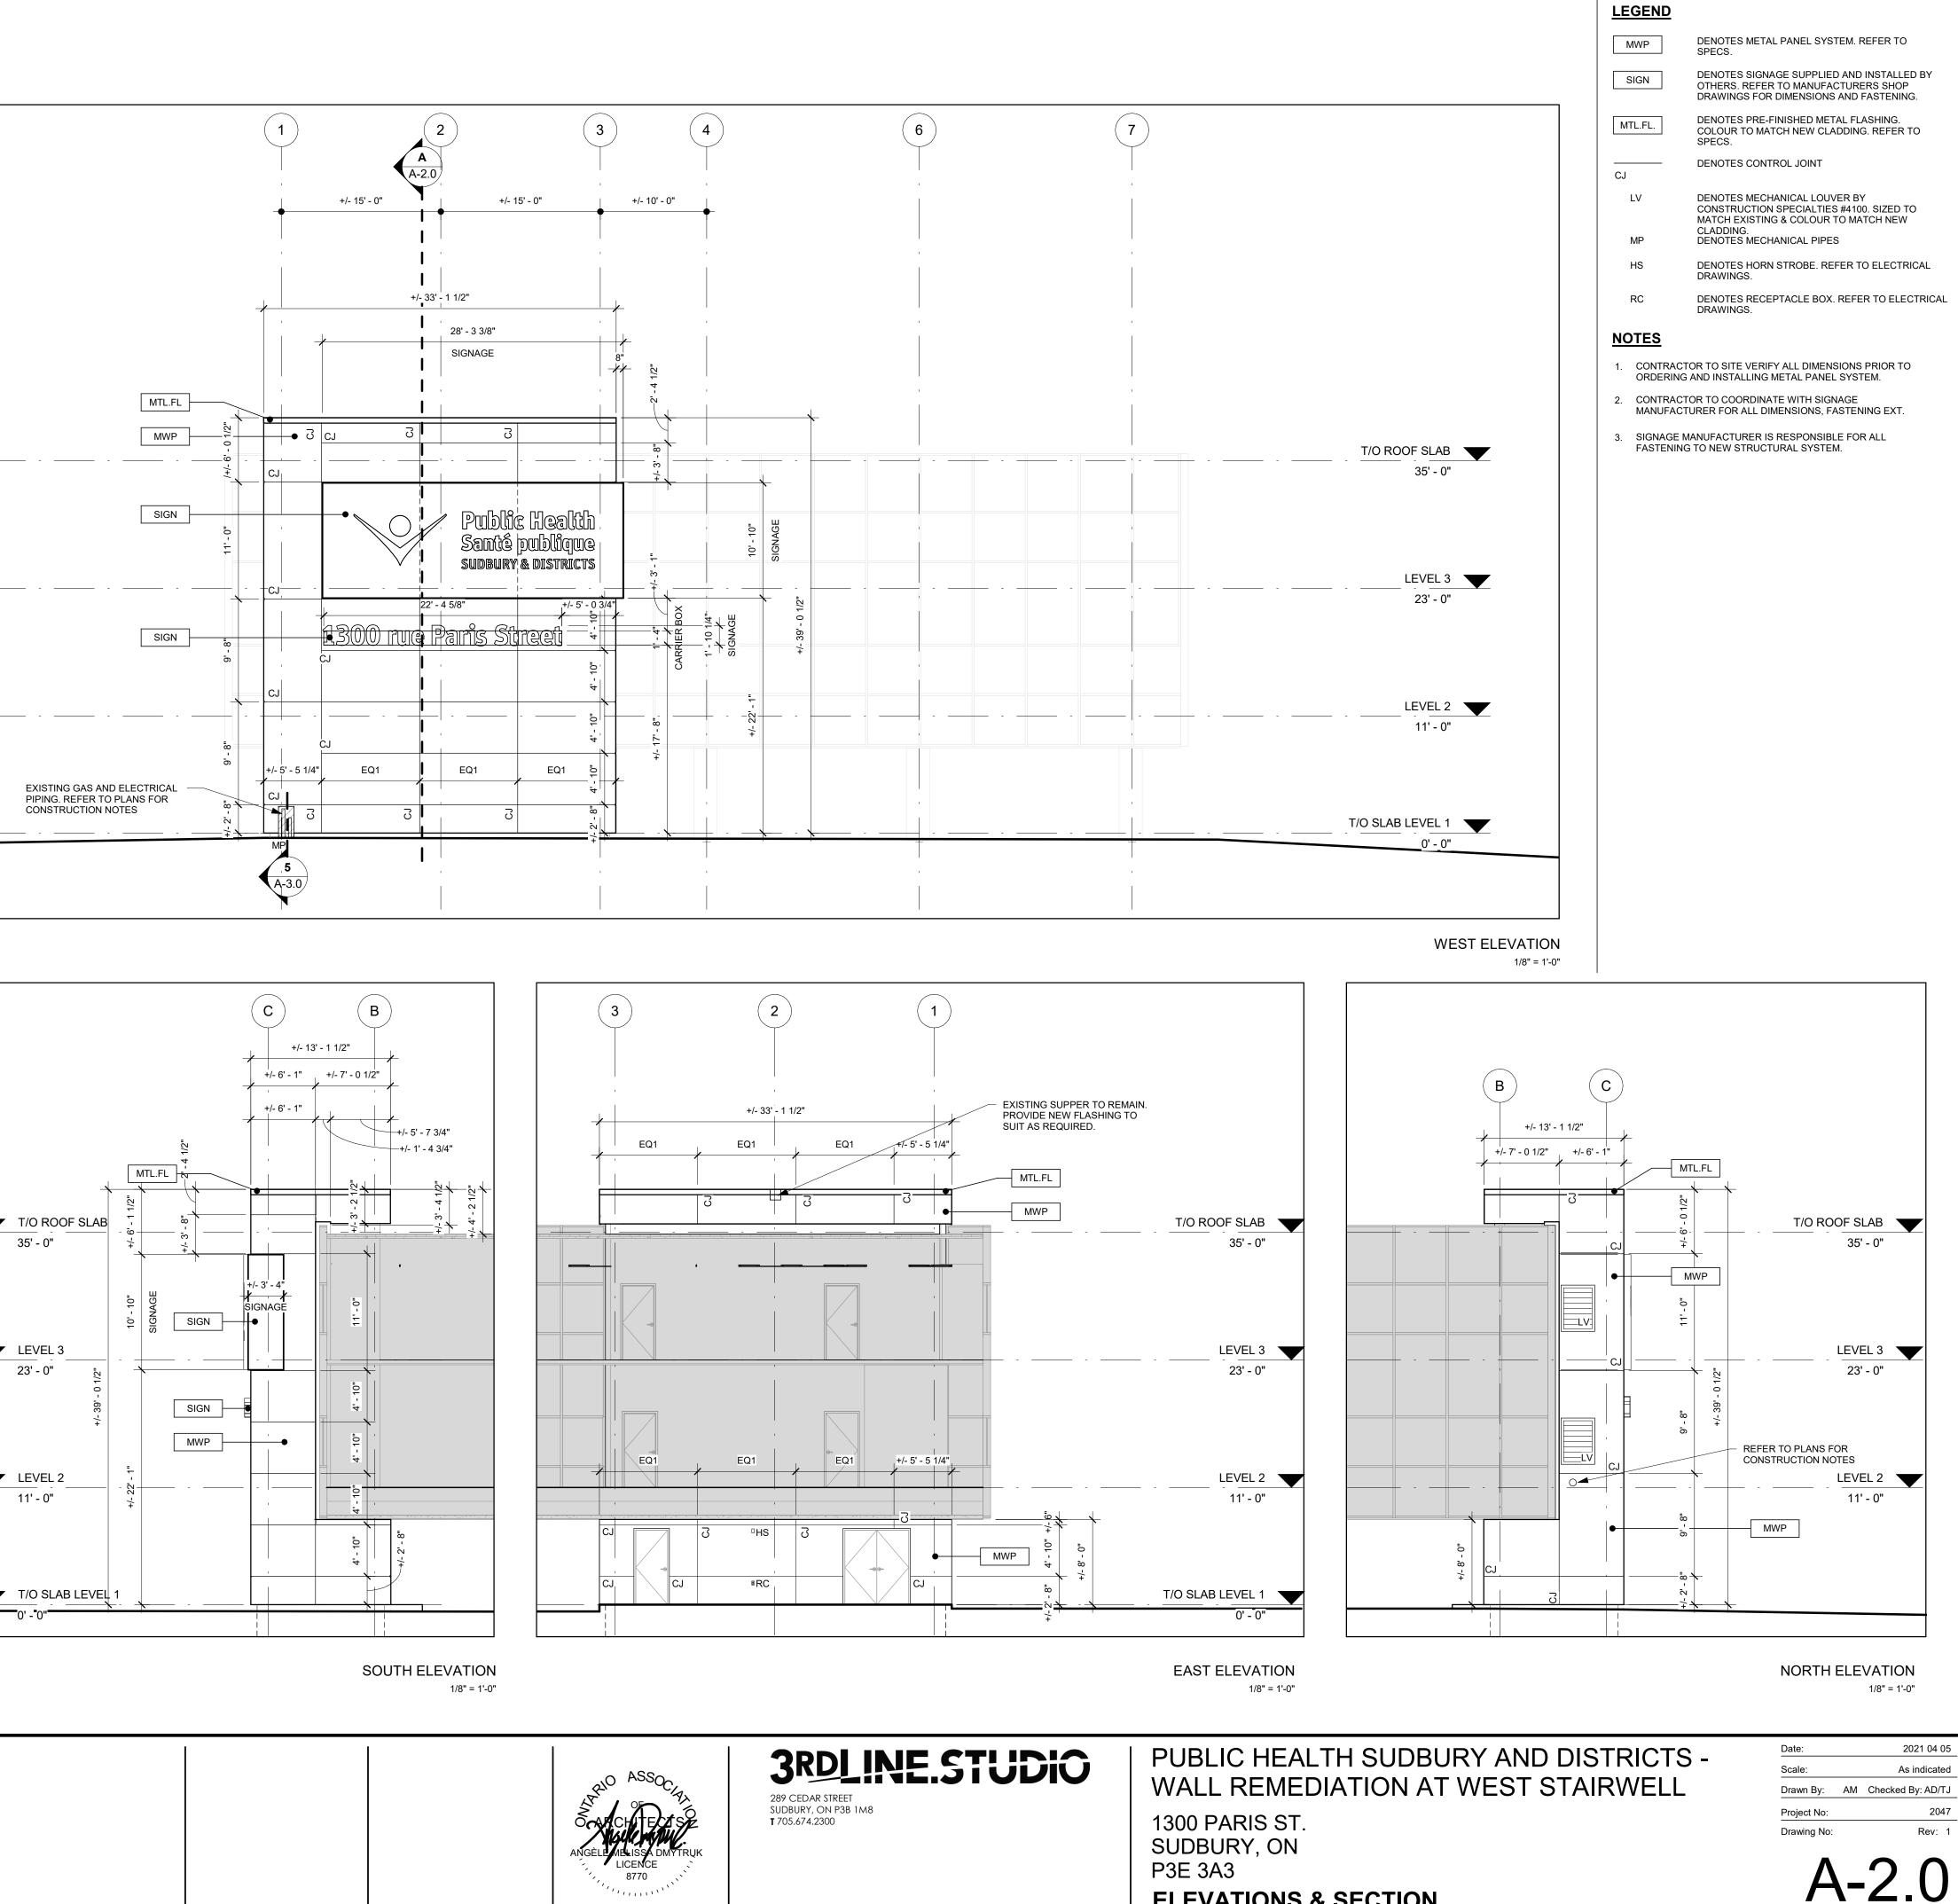

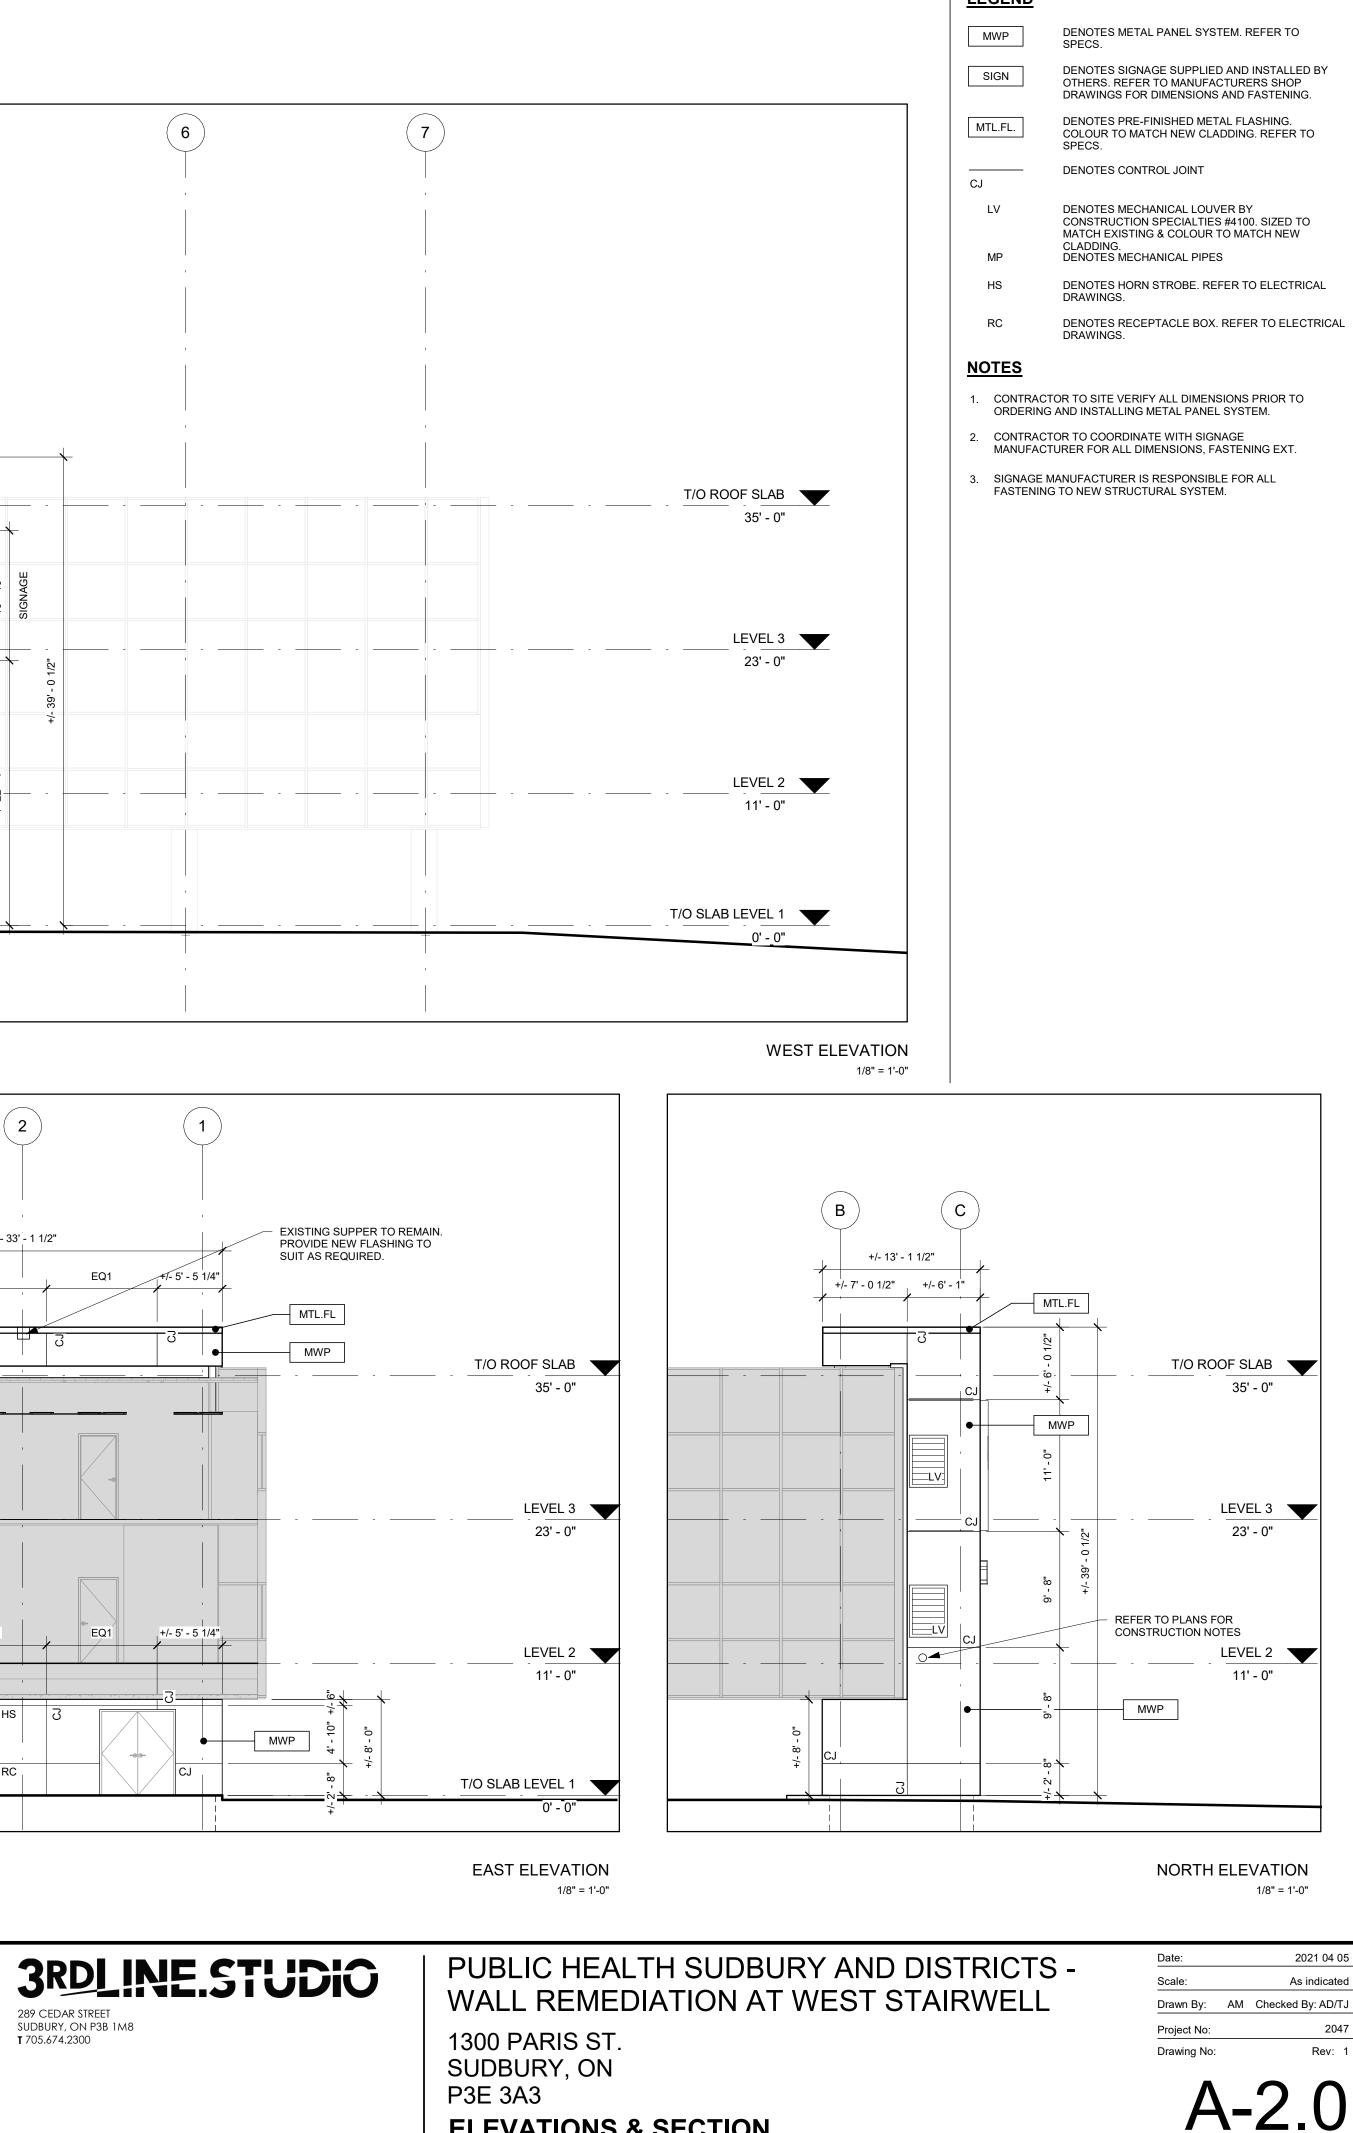




ELEVATIONS & SECTION

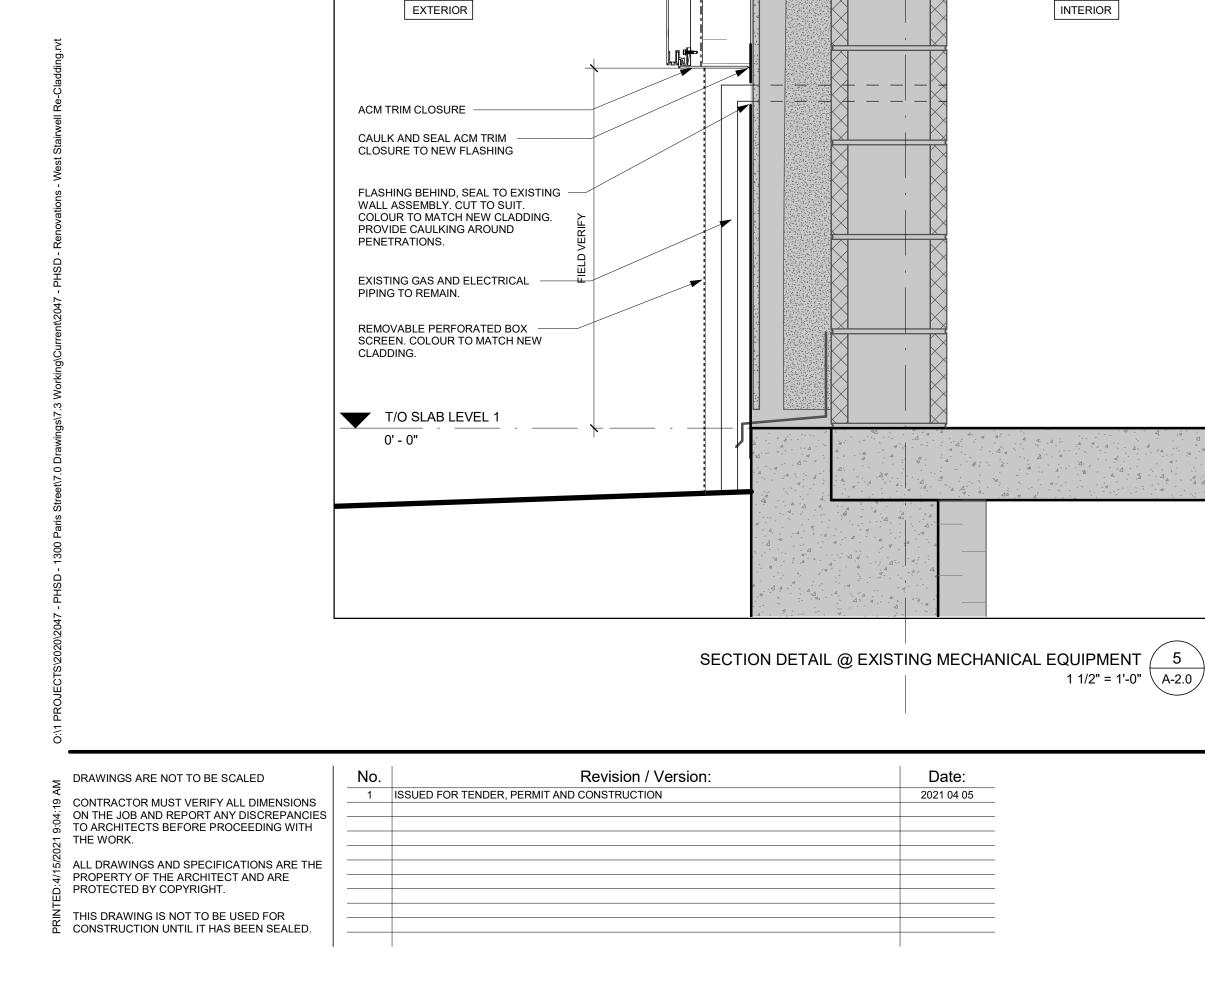

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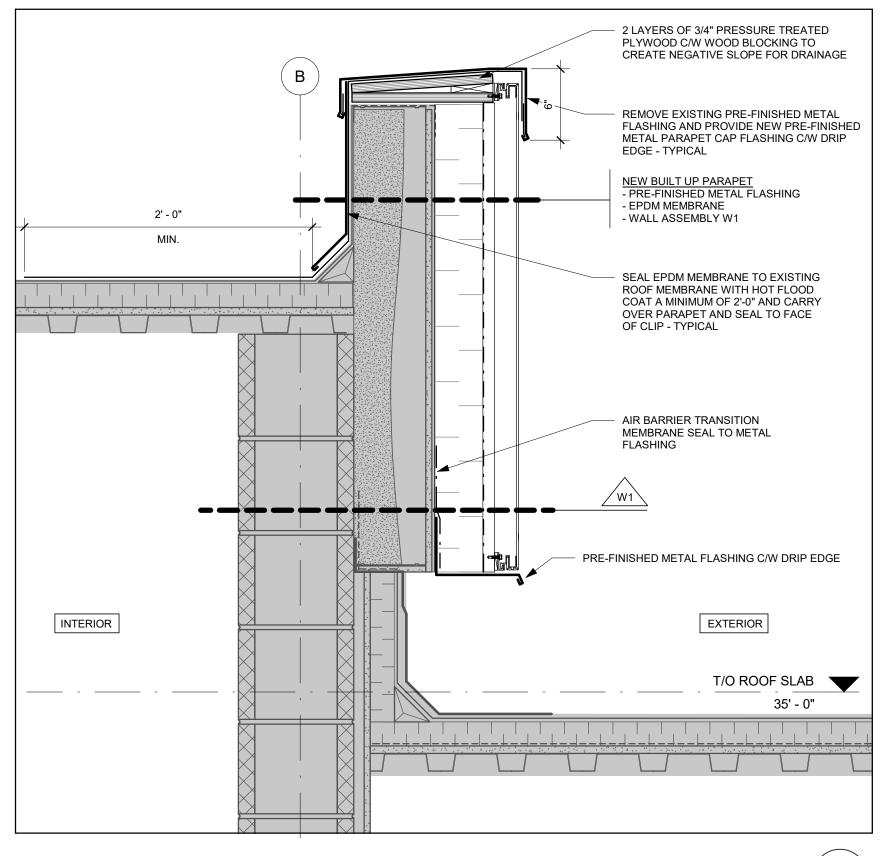
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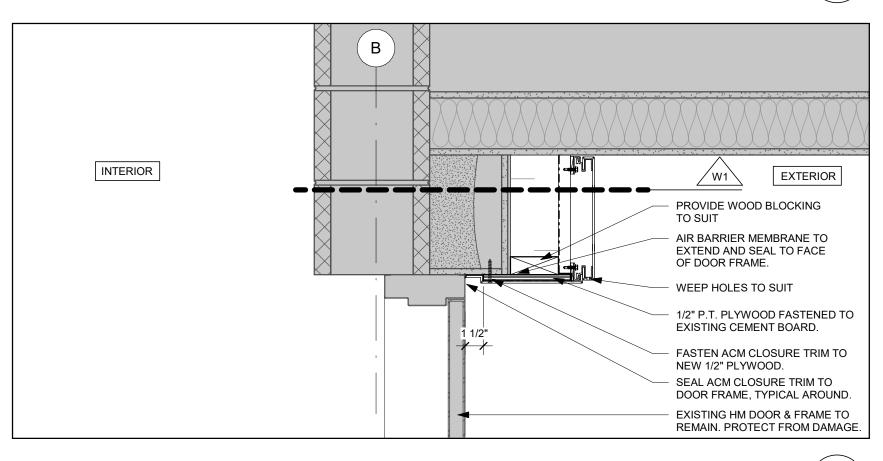
SECTION DETAIL @ PERIMETER OF NEW SIGNAGE 4 1 1/2" = 1'-0" 4 A-2.0

> 289 CEDAR STREET SUDBURY, ON P3B 1M8 T 705.674.2300




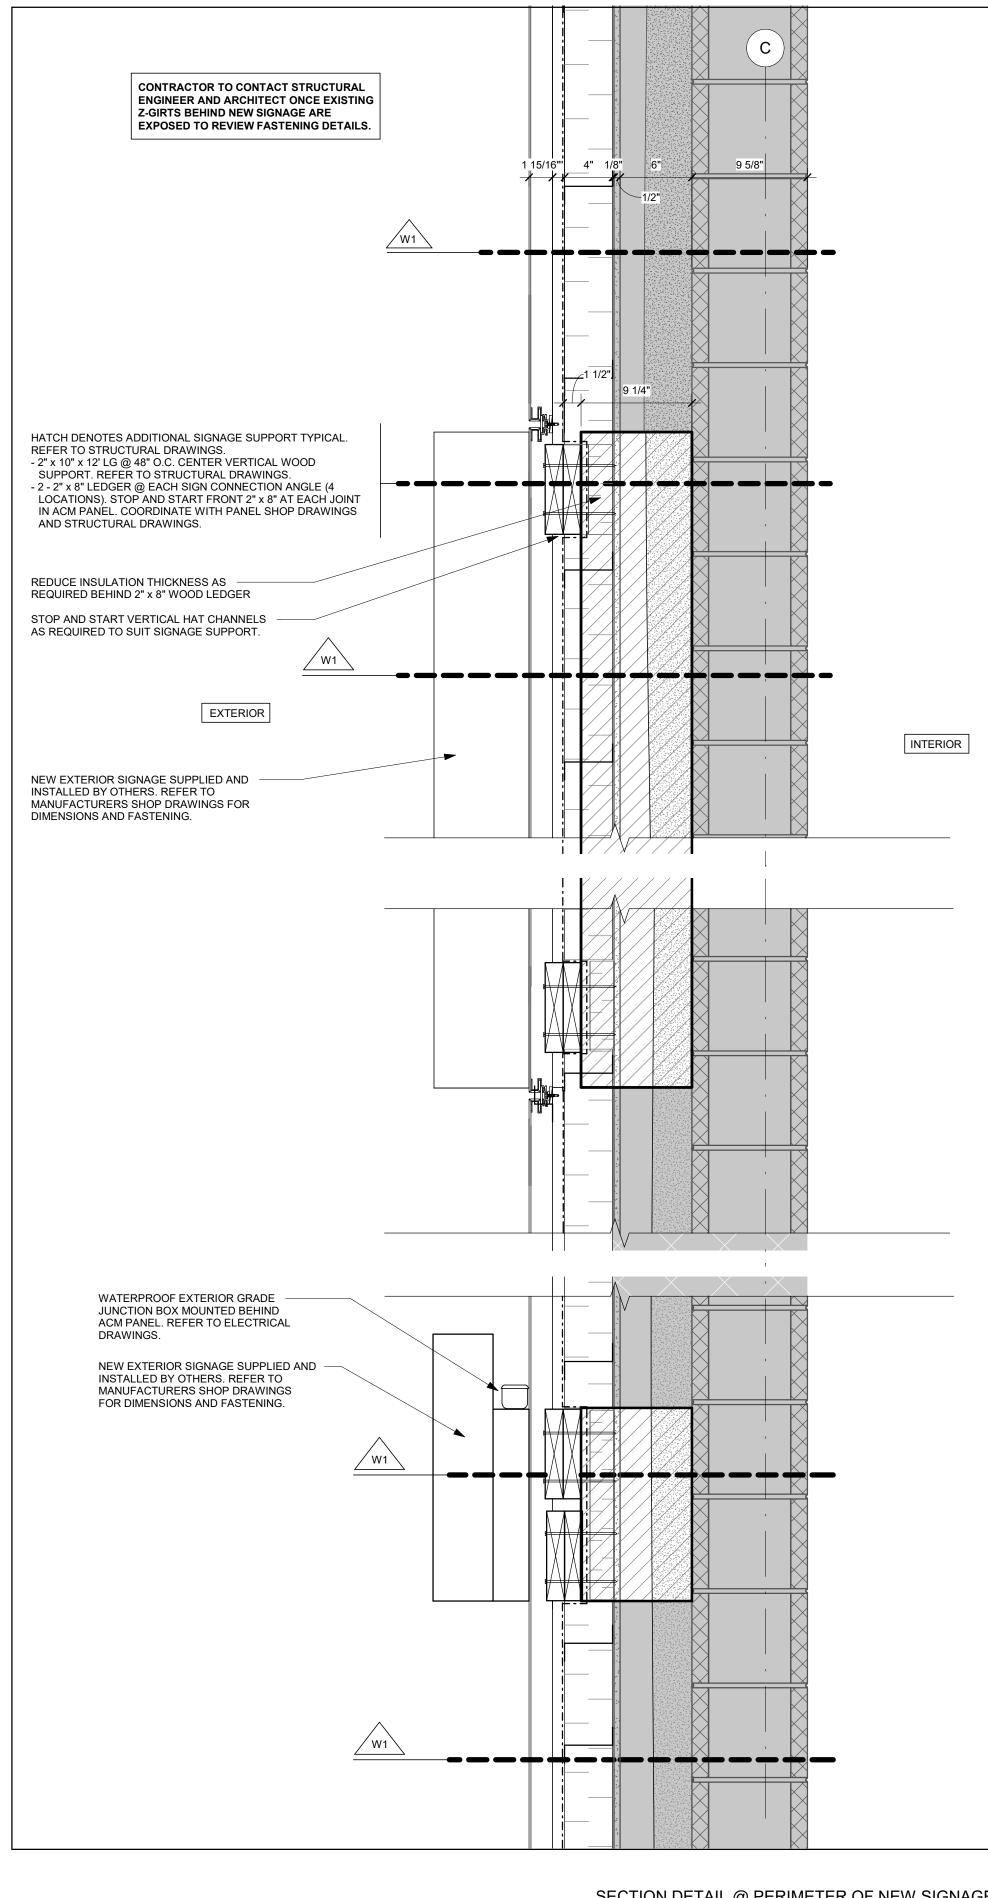


SECTION DETAIL @ PARAPET / LOWER ROOF $\begin{pmatrix} 3 \\ 1 & 1/2'' = 1'-0'' \end{pmatrix}$



SECTION DETAIL @ DOOR HEAD 2 1 1/2" = 1'-0" 4-2.0

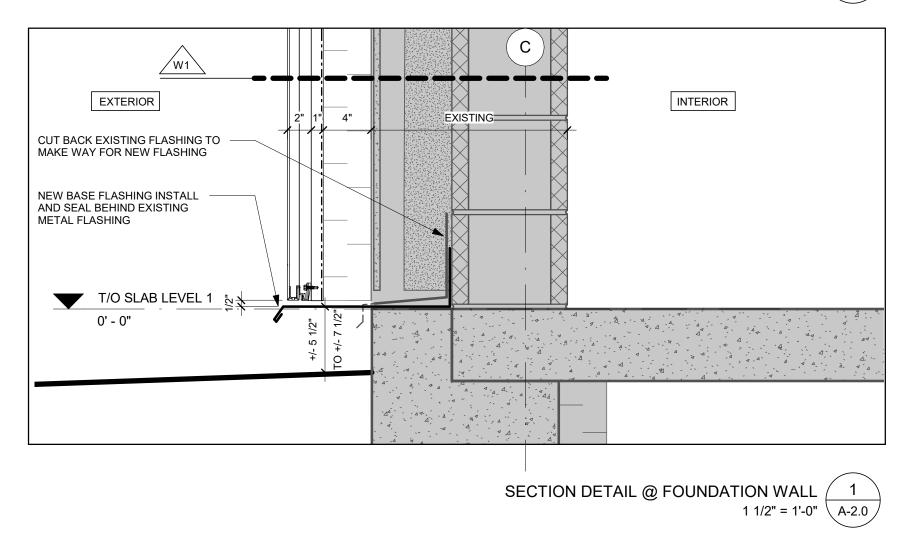

PUBLIC HEALTH SUDBURY AND DISTRICTS -WALL REMEDIATION AT WEST STAIRWELL 1300 PARIS ST.

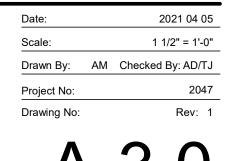

P3E 3A3 SECTION & PLAN DETAILS

SUDBURY, ON


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DRAWINGS ARE NOT TO BE SCALED	No.	Revision / Version:	Date:
CONTRACTOR MUST VERIFY ALL DIMENSIONS ON THE JOB AND REPORT ANY DISCREPANCIES TO ARCHITECTS BEFORE PROCEEDING WITH THE WORK.	1	ISSUED FOR TENDER, PERMIT AND CONSTRUCTION	2021 04 05
ALL DRAWINGS AND SPECIFICATIONS ARE THE PROPERTY OF THE ARCHITECT AND ARE PROTECTED BY COPYRIGHT.			
THIS DRAWING IS NOT TO BE USED FOR CONSTRUCTION UNTIL IT HAS BEEN SEALED.			






289 Cedar Street Sudbury, on p3B 1m8 **T** 705.674.2300

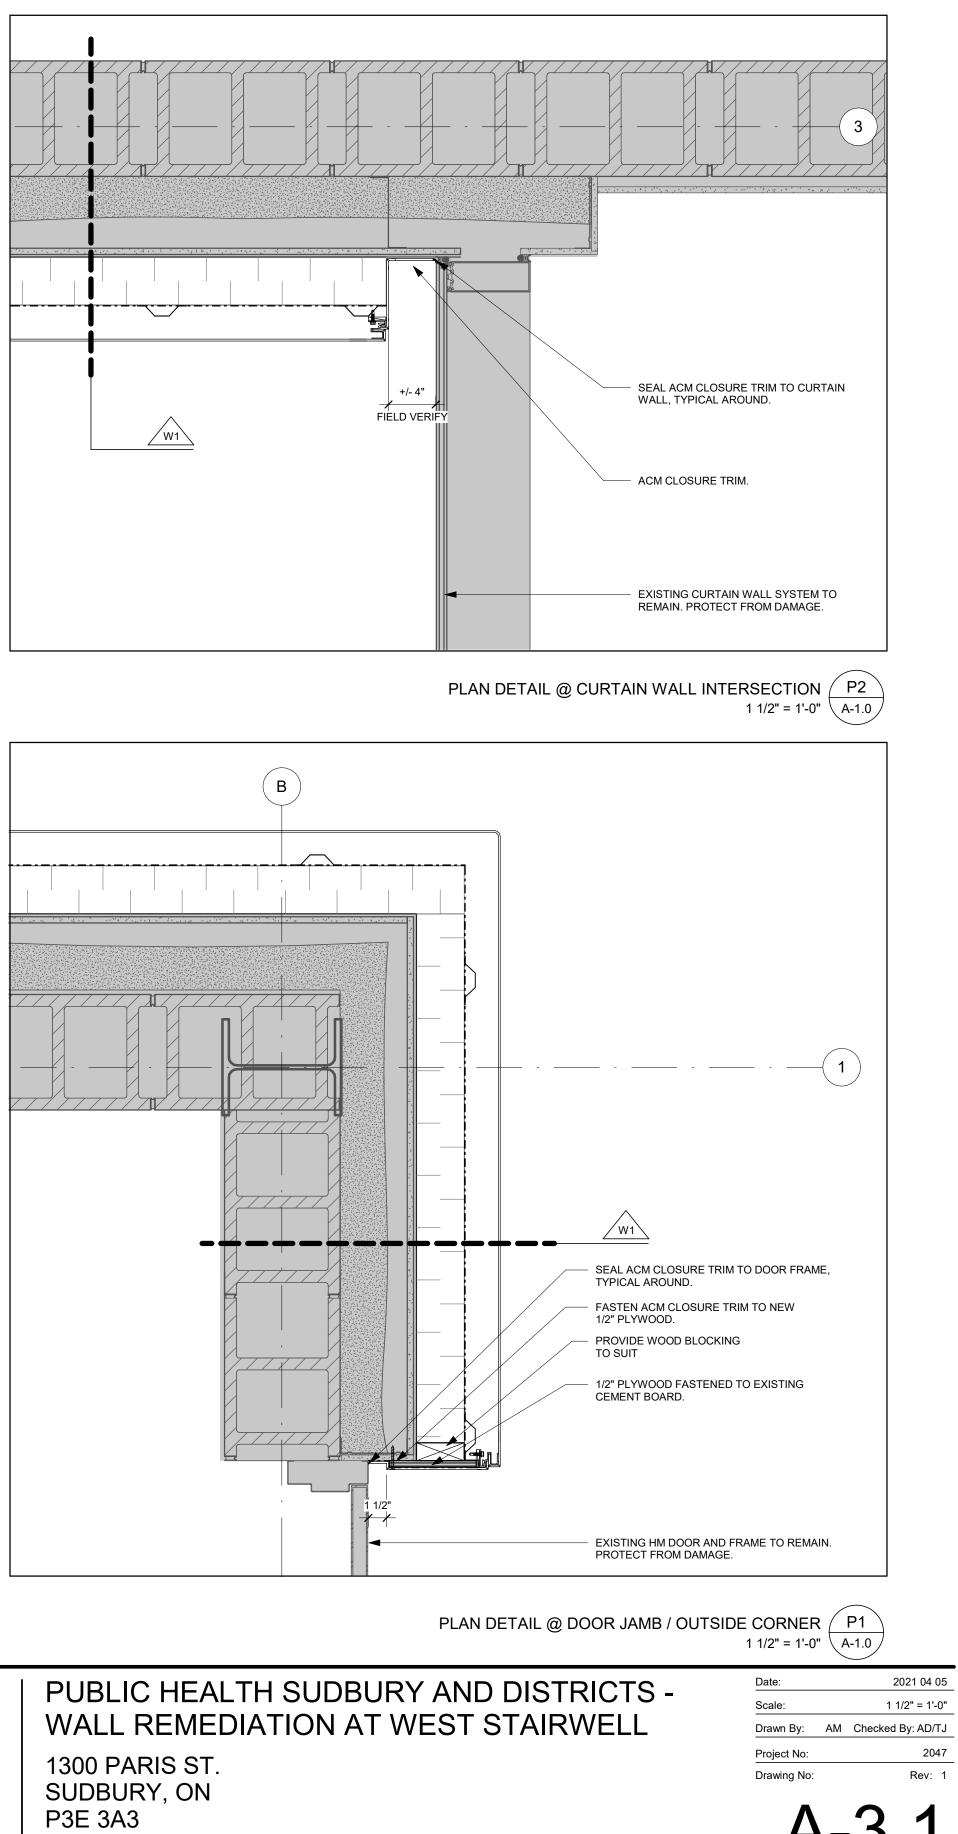

PLAN DETAILS

Rev: 1 A-3.1

2047

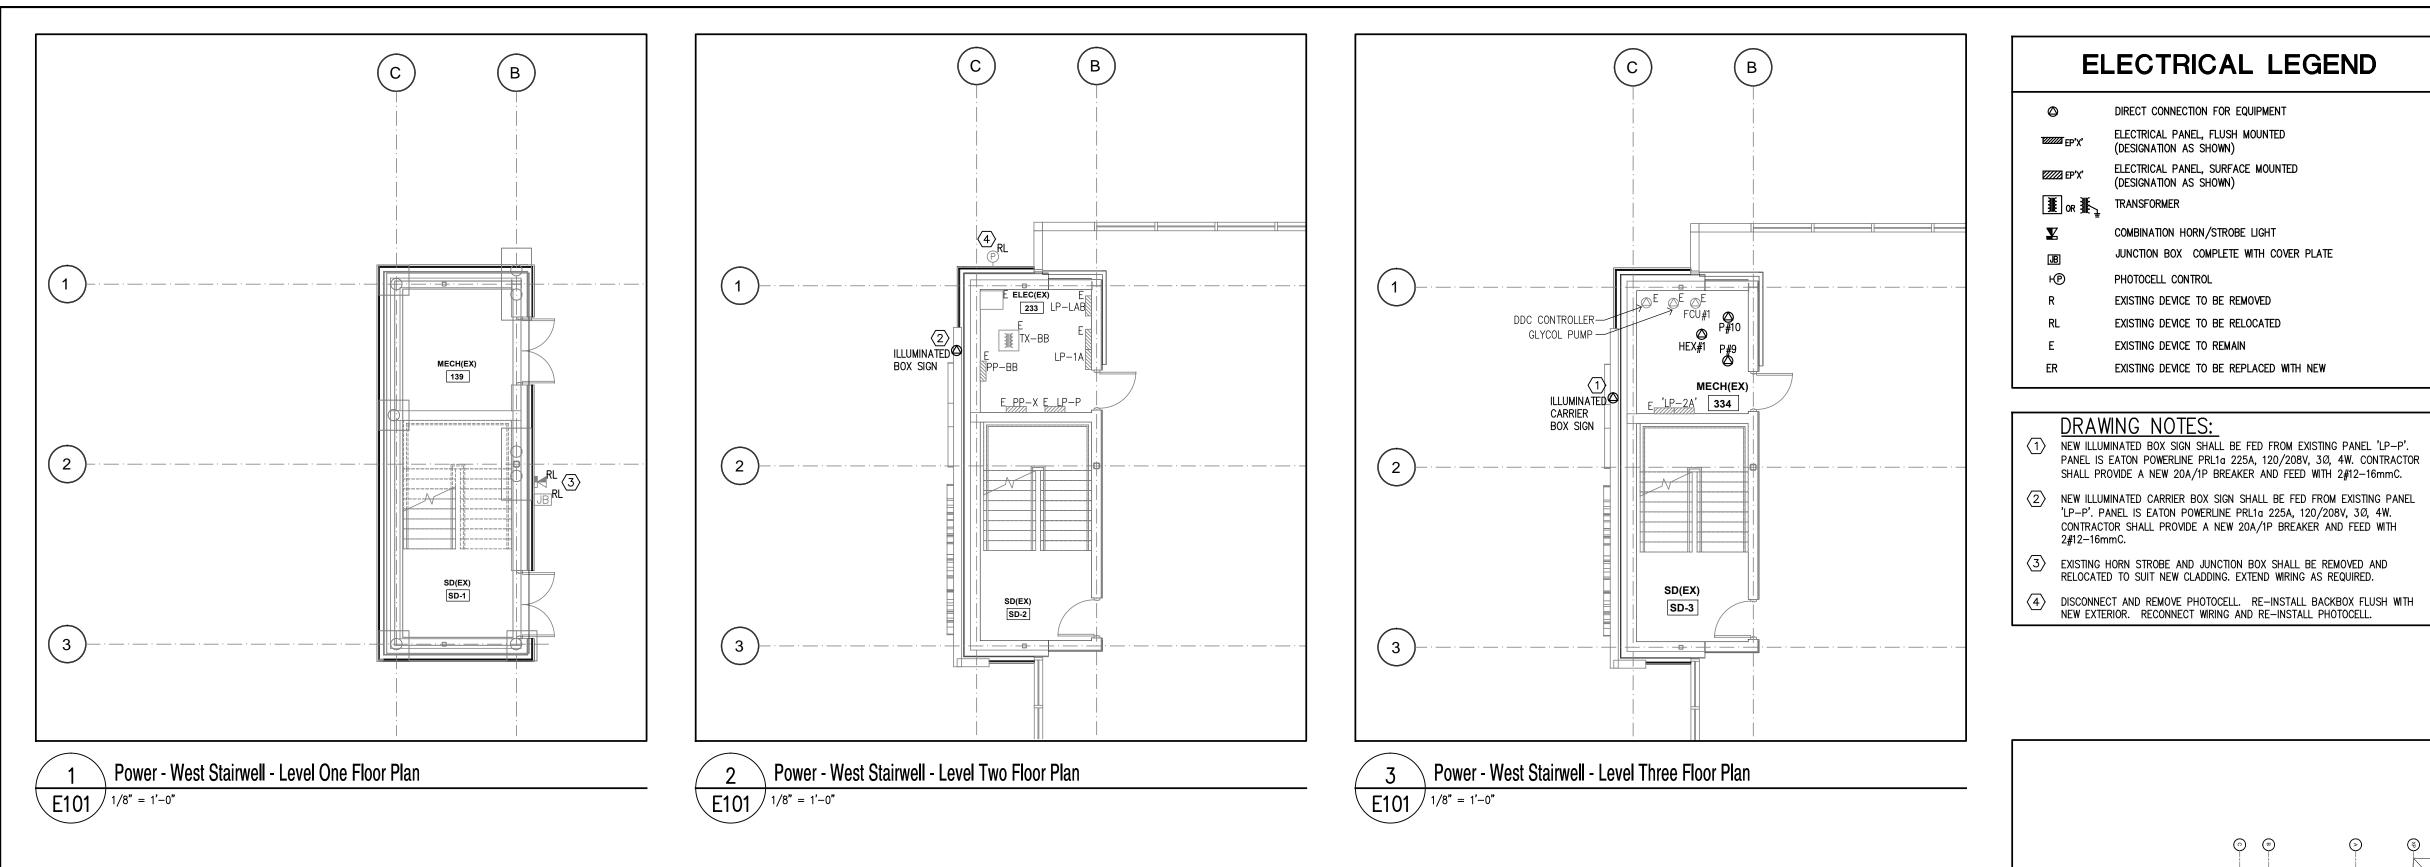


Key Plan

(1-3) E101


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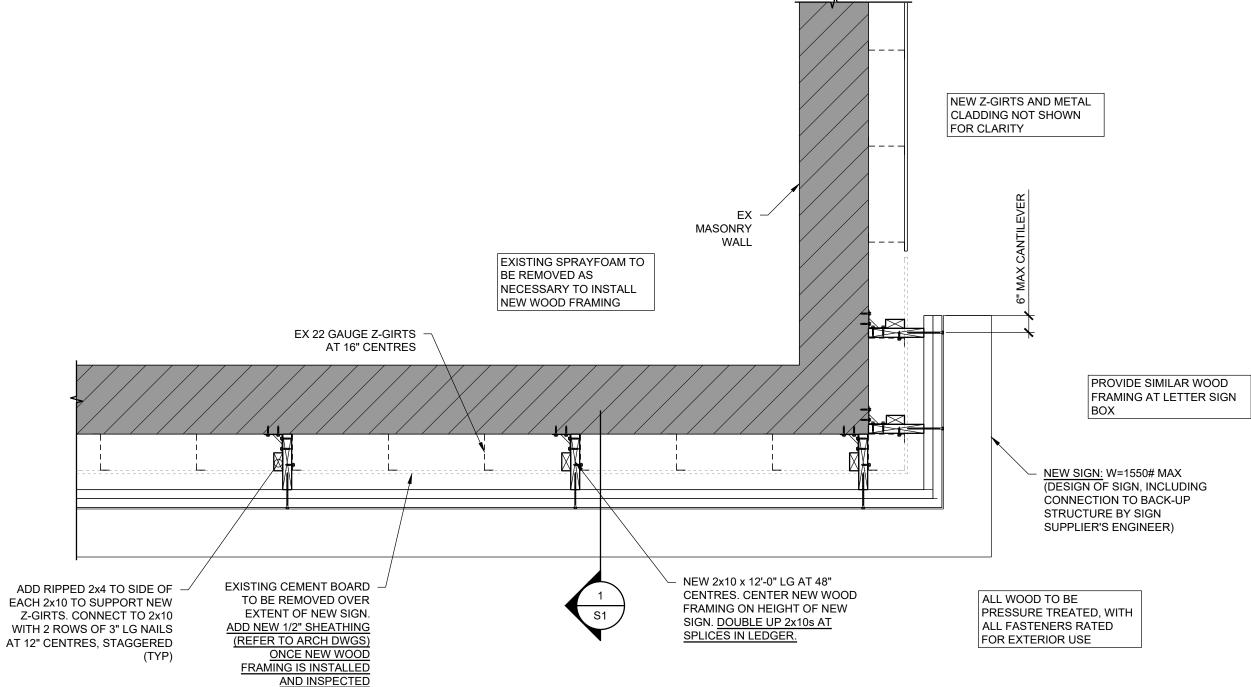
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	LECTRICAL GENERAL NOTES: ENTIRE INSTALLATION SHALL BE IN ACCORDANCE WITH THE ONTARIO ELECTRICAL SAFETY CODE.
2.	ELECTRICAL CONTRACTOR IS TO OBTAIN ALL APPROVALS FROM LOCAL ELECTRICAL SAFETY AUTHORITY PRIOR TO COMMENCING WORK.
3.	ALL DEVICES SHOWN ARE NEW, UNLESS OTHERWISE NOTED.
4.	FIRE STOP ALL PENETRATIONS THRU FIRE RATED ASSEMBLIES.
5.	ALL WIRING TO BE CONCEALED WHERE POSSIBLE. IF NOT POSSIBLE, PROVIDE SURFACE MOUNTED METAL RACEWAY AND MATCHING SURFACE MOUNTED BOX. RACEWAY TO BE SAME COLOUR AS BACKGROUND SURFACE, AND BE RAN AS NEAT AS POSSIBLE, PARALLEL / PERPENDICULAR TO BUILDING LINES. CONFIRM INSTALLATION DETAILS PRIOR TO ROUGH-IN.
6.	COORDINATE ALL WORK WITH ARCHITECTURAL DRAWING AND SPECIFICATIONS.
_	DWER GENERAL NOTES: PROVIDE BONDING CONDUCTOR AND CONNECTION (AS PER OESC) FOR ALL PERMANENTLY CONNECTED EQUIPMENT. COORDINATE EXACT REQUIREMENTS ON SITE.
2.	BRANCH CIRCUIT WIRING IN CONCEALED SPACES TO BE INSTALLED IN CONDUIT. REFER TO THE SPECIFICATIONS ON THE MAXIMUM LENGTH OF ARMOURED CABLES THAT CAN BE USED.
3.	COORDINATE EXACT LOCATION OF ALL DEVICES ON SITE WITH EQUIPMENT SHOWN ON ARCHITECTURAL PLANS, PRIOR TO ROUGH-IN.
4.	ENSURE A MINIMUM OF 1M CLEARANCE IS MAINTAINED IN FRONT OF ALL PANELS AND DISCONNECT SWITCHES.
5.	ELECTRICAL CONTRACTOR TO PROVIDE THE DEVICE INFORMATION ON ALL CIRCUITS IN THE PANEL SCHEDULE. (FOR EXAMPLE, RECEPT - RM 100)
	RE ALARM GENERAL NOTES: RELOCATE FIRE ALARM DEVICES AS SHOWN AND PROVIDE PARTIAL FIRE ALARM SYSTEM VERIFICATION (TO CAN/ULC-S537 STANDARDS) UPON COMPLETION.





APR. 07, 202 1. ISSUED FOR TENDER revision date the Contractor shall check and verify all dimensions before proceeding with the work A detail no. B sheet no. where detailed Drawings are a property of Piotrowski Consultants Ltd. and are protected by copyright. Reproduction of any kind is strictly prohibited. ROFESS/O APR 07/21 R.D.MACVICAR 100128434 Le lle **Consultants Limited** 1820 Bond St. North Bay, Ontario, P1B 4V6 Ph. 705-472-2536 Fx. 705-476-5105 Email - pcl@piotrowskiconsultants.ca project PUBLIC HEALTH SUDBURY & DISTRICTS WALL REMEDIATION AT WEST STAIRWELL SUDBURY ONTARIO title ELECTRICAL POWER LEGEND, NOTES, DETAILS & FLOOR PLAN drawn by: date: MARCH 2021 ΕH checked by: project no: 6373A NGA/RM scale: dwg no: AS NOTED E101 plotted: April 6, 2021

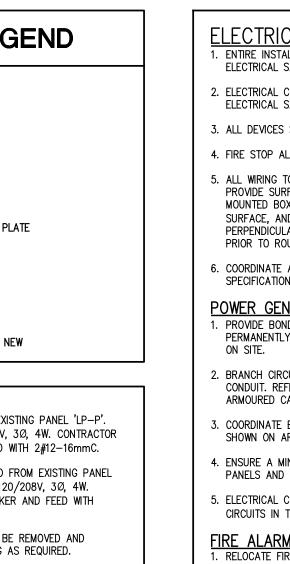



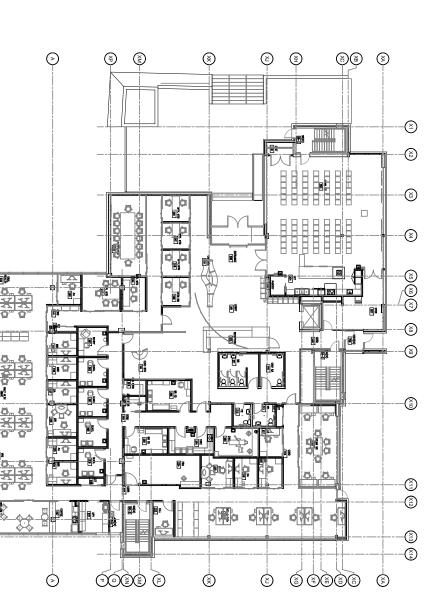

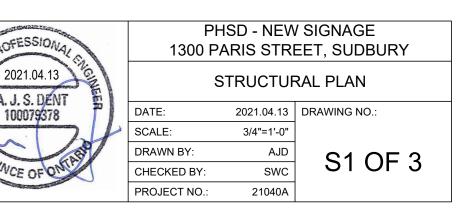

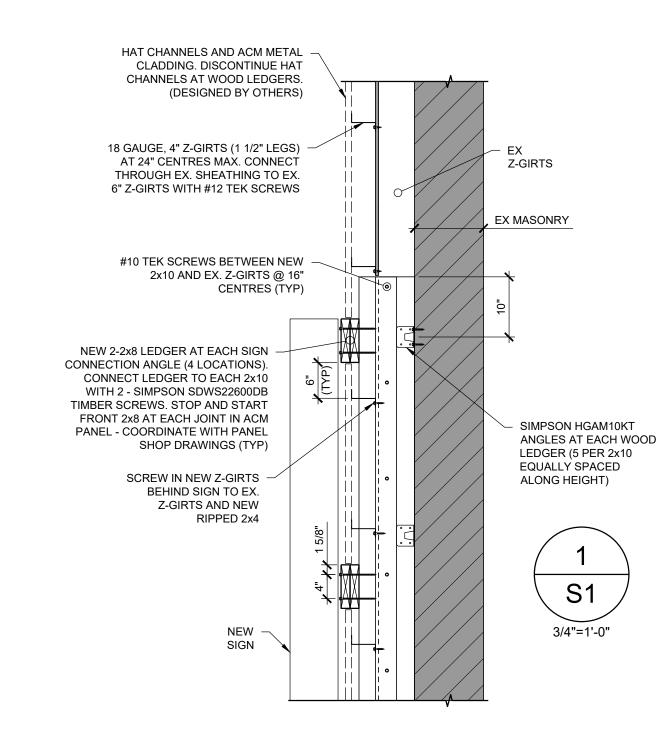

		CONNECTION SCHEDULE			
	# OF PLIES	CONNECTORS AND DETAILS			
	2	76 (3") LONG SIMPSON SDW SCREWS IN 2 ROWS @ 406 (16") C/C MAX.			
	3	117 (4 5/8") LONG SIMPSON SDW SCREWS IN 2 ROWS @ 305 (12") C/C MAX			
	4 152 (6") LONG SIMPSON SDW SCREWS IN 2 ROWS @ 305 (12") C/C MAX				
-	STAGGER S	SCREWS ON EACH FACE OF BEAM.			
-	- LOCATE FIRST ROW OF SCREWS 152 (6") FROM EACH END.				
-	LOCATE SCREWS 38 (1 1/2") FROM EDGE.				
-	ADD ADDITIONAL ROW OF SCREWS FOR BEAMS DEEPER				

- ADD ADDITIONAL ROW OF SCREWS FOR BEAMS DEEPER THAN 229 (9").

TDW05	CONNECTIONS FOR SIDE-LOADED BUILT-UP WOOD (DIMENSIONAL LUMBER) BEAMS



10AL	PHSD - NEW SIGNAGE			
ALC	1300 P	PARIS STRI	EET, SUDBURY	
4.13	STRUCTURAL SECTIONS AND DETAILS			
378	DATE:	2021.04.13	DRAWING NO.:	
24	SCALE:	3/4"=1'-0"		
C SS	DRAWN BY:	AJD	S2 OF 3	
= ON	CHECKED BY:	SWC	JZ UF J	
	PROJECT NO.:	21040A		

STRUCTURAL WORK

GENERAL

- COMPLY WITH THE REQUIREMENTS OF THE ONTARIO BUILDING CODE AND THE OCCUPATIONAL HEALTH AND 1.1. SAFETY ACT AND REGULATIONS FOR CONSTRUCTION PROJECTS.
 - 1.1.1. A BUILDING PERMIT IS REQUIRED FOR ALL STRUCTURAL WORKS UNLESS OTHERWISE NOTED BY THE CHIEF BUILDING OFFICIAL OR AUTHORITY HAVING JURISDICTION.
- PROVIDE ALL MATERIAL AND LABOUR REQUIRED FOR THE COMPLETION OF THE WORK. BREAKDOWN OF WORK 1.2. BY TRADE IS FOR GUIDANCE ONLY AND IS NOT NECESSARILY COMPLETE.
- REVIEW STRUCTURAL DRAWINGS IN CONJUNCTION WITH THE CONTRACT DOCUMENTS PREPARED BY ALL 1.3 CONSULTANTS PRIOR TO CONSTRUCTION, REPORT DISCREPANCIES BEFORE PROCEEDING WITH THE WORK.
- DO NOT SCALE THESE DRAWINGS. 14
- 15 COORDINATE ALL OPENINGS, SLEEVES AND EMBEDDED ITEMS IN STRUCTURE WITH THE CONTRACT DOCUMENTS PREPARED BY ALL CONSULTANTS. REPORT ANY CONFLICTS BEFORE PROCEEDING WITH THE WORK.
- 1.6 DO NOT CUT OR DRILL ANY OPENINGS IN STRUCTURAL MEMBERS WITHOUT WRITTEN PERMISSION FROM THE STRUCTURAL CONSULTANT UNLESS SPECIFICALLY NOTED ON THE STRUCTURAL DRAWINGS.
- 2. TEMPORARY WORKS
 - 2.1. STRUCTURAL DRAWINGS SHOW THE INTENT OF THE COMPLETED STRUCTURE. THE CONTRACTOR IS RESPONSIBLE FOR DETERMINING THE SCOPE, DESIGN AND ERECTION OF ALL TEMPORARY WORKS THAT ARE NECESSARY TO COMPLETE THE WORK. TEMPORARY WORKS MAY BE REQUIRED THAT ARE NOT SHOWN ON STRUCTURAL DRAWINGS.
 - 2.2. MAKE GOOD ALL EXISTING WORK DISTURBED BY TEMPORARY CONSTRUCTION OPERATIONS.
- 3. EXISTING STRUCTURES
 - VERIFY EXISTING DIMENSIONS AND CONDITIONS ON SITE PRIOR TO CONSTRUCTION. 3.1
 - TAKE ALL PRECAUTIONS NECESSARY TO PROTECT EXISTING STRUCTURES DURING CONSTRUCTION. 3.2.
 - EXISTING CONDITIONS ARE ASSUMED. REPORT ANY VARIATIONS TO THE STRUCTURAL CONSULTANT BEFORE 3.3. PROCEEDING WITH THE WORK.
- INSPECTION AND TESTING 4
 - COOPERATE WITH CONSULTANTS DOING GENERAL REVIEW AND ALL INSPECTION AND TESTING AGENCIES. 4.1. PROVIDE SAFE ACCESS TO WORK AREAS AS REQUIRED AND ASSIST IN THEIR WORK. PROVIDE REASONABLE NOTICE (NOT LESS THAN 48 HOURS) PRIOR TO CONCEALING ANY WORK THAT REQUIRES INSPECTION, REVIEW, OR TESTING. SCHEDULE THIS WORK TO OCCUR DURING NORMAL BUSINESS HOURS. ENSURE THAT THE WORK TO BE REVIEWED IS SUBSTANTIALLY COMPLETE IN TIME FOR THE REVIEW.
 - THE STRUCTURAL CONSULTANT WILL PROVIDE GENERAL REVIEW OF THE WORK DESIGNED BY THE 4.2. CONSULTANT ON A RATIONAL SAMPLING BASIS IN ACCORDANCE WITH THE GUIDELINE: "PROFESSIONAL ENGINEERS PROVIDING GENERAL REVIEW OF CONSTRUCTION AS REQUIRED BY THE ONTARIO BUILDING CODE" AS PREPARED BY PROFESSIONAL ENGINEERS ONTARIO. THESE REVIEWS DO NOT ALLEVIATE THE CONTRACTOR OF THEIR RESPONSIBILITY TO COMPLETE THE WORK IN ACCORDANCE WITH THE CONTRACT DOCUMENTS WITH AN APPROPRIATE QUALITY CONTROL PROGRAM.
 - ENSURE THAT GENERAL REVIEW IS PROVIDED FOR ALL STRUCTURAL WORK DESIGNED BY A PROFESSIONAL 43 ENGINEER RETAINED BY THE CONTRACTOR. GENERAL REVIEW TO BE BY THE ENGINEER RESPONSIBLE FOR THE DESIGN OR BY ANOTHER PROFESSIONAL ENGINEER LICENSED AND INSURED IN ONTARIO. SUBMIT GENERAL REVIEW REPORTS FOR REVIEW.
- 5. COLD-FORMED STEEL FRAMING (CFS)
 - CONFORM TO CAN/CSA S136: "NORTH AMERICAN SPECIFICATION FOR THE DESIGN OF COLD-FORMED STEEL 5.1. STRUCTURAL MEMBERS".
 - MATERIALS: 5.2.
 - 5.2.1. THICKNESS LESS THAN OR EQUAL TO 0.0451": A653/653M GRADE A. 230W
 - 5.2.2. THICKNESS GREATER THAN 0.0451": A653/653M GRADE D, 350W
 - FASTENERS: 53
 - 5.3.1. FASTENERS SPECIFICALLY NOTED ELSEWHERE ON THE STRUCTURAL DRAWINGS GOVERN.
 - CFS-TO-CFS FASTENERS TO BE BUILDEX #10-16 TEKS/1 OR #10-16 TEKS/3 SELF-DRILLING, SELF-TAPPING 5.3.2. SCREWS OR APPROVED EQUIVALENT, PROVIDE ELECTRO-ZINC (EZ) COATING.
 - WOOD-TO-CFS FASTENERS (INCLUDING SHEATHING) TO BE #10-16 TEKS/3 SELF-DRILLING, SELF-TAPPING 5.3.3. SCREWS OR APPROVED EQUIVALENT. PROVIDE ELECTRO-ZINC (EZ) COATING. FASTENERS ARE TO BE INSTALLED FROM THE WOOD INTO THE LGM.

- 534 OVERDRIVE.
- 6. STRUCTURAL WOOD
 - CONFORM TO CSA 086: "ENGINEERING DESIGN IN WOOD" 6.1
 - 6.2 MATERIALS:
 - 6.2.1. LUMBER CONFORMING TO CSA 0141.
 - WORKS.
 - 6.2.1.2. KILN DRIED WITH MAXIMUM MOISTURE CONTENT OF 19%.
 - 622 NOT SUBSTITUTE WITH BOX NAILS.

	PENNY	MIN. DIAMETER	MIN. DIAMETER	MIN. DIAMETER
LENGTH	WEIGHT	COMMON WIRE	COMMON SPIRAL	PNEUMATIC
76 (3")	10d	3.66 (0.144")	3.10 (0.122")	3.05 (0.120")

- 6.2.3. SUBSTITUTE FASTENERS.
- CONNECT BUILT-UP MEMBERS AS PER THE TYPICAL DETAILS OR AS RECOMMENDED BY THE SUPPLIER (FOR 63 NOT PERMITTED IN BUILT-UP MEMBERS.
- DO NOT NOTCH STRUCTURAL WOOD MEMBERS WITHOUT THE WRITTEN CONSENT OF THE DESIGNER AND/OR 6.4. CONSULTANT.
- 7. DESIGN DATA
 - 7.1. STRUCTURAL DESIGN IS IN ACCORDANCE WITH THE ONTARIO BUILDING CODE 2012 SUPPLEMENTED BY THE USER'S GUIDE - NBC 2015 STRUCTURAL COMMENTARIES (PART 4 OF DIVISION B).
 - CLIMATIC LOCATION: SUDBURY, ONTARIO 72
 - 7.3. IMPORTANCE CATEGORY: NORMAL
 - UNLESS OTHERWISE NOTED, DESIGN LOADS SHOWN ARE SPECIFIED (UNFACTORED). FOR POINT LOADS, IF ONLY 74 ONE LOAD IS GIVEN, CONSIDER IT LIVE LOAD.
 - 7.5. WIND LOADS
 - 7.5.1. q(1/50) = 0.46 kPa
 - 7.5.2. Ce = 0.70 Cg = 2.5 Cp = -1.2
 - 7.5.3. WL = lw(0.46) (0.7)(2.5)(-1.2) = 0.97 kPa = 1.35 kPa (ULS)



SELF-DRILLING SCREWS: MINIMUM PENETRATION BEYOND METAL IS 3 PITCHES OF THREAD. DO NOT

6.2.1.1. SPRUCE-PINE-FIR (SPF) NO.1/NO.2 MINIMUM. STUD GRADE IS NOT PERMITTED IN STRUCTURAL

NAILS TO BE COMMON ROUND OR SPIRAL STEEL WIRE CONFORMING TO CSA B111 OR ASTM F1667. DO

ALL CONNECTORS BY SIMPSON STRONG-TIE OR EQUIVALENT APPROVED BY THE CONSULTANT PRIOR TO CONSTRUCTION. FASTEN TO STRUCTURE PER THE MANUFACTURERS REQUIREMENTS. DO NOT

STRUCTURAL COMPOSITE LUMBER) UNLESS OTHERWISE NOTED ON THE CONTRACT DOCUMENTS. SPLICES ARE

2021.04

A. J. S.

10007

SIONAL	PHSD - NEW SIGNAGE 1300 PARIS STREET, SUDBURY				
4.13 C	STRUCTURAL NOTES				
9378	DATE:	2021.04.13	DRAWING NO .:		
24	SCALE:	NTS			
C SS	DRAWN BY:	AJD	S3 OF 3		
FON	CHECKED BY:	SWC	33 UF 3		
	PROJECT NO .:	21040A			